



**AMERICAN FORK CITY
NOTICE OF PUBLIC HEARING
&
PLANNING COMMISSION REGULAR SESSION
March 22nd, 2023
7:00 p.m.**

Notice is hereby given that the American Fork City Planning Commission will meet in regular session on March 22nd, 2023 at the American Fork City Hall, 31 North Church Street, commencing at 7:00 p.m. The agenda shall be as follows:

REGULAR SESSION

Pledge of Allegiance

Roll call

COMMON CONSENT AGENDA

(Common Consent is that class of Commission action that requires no further discussion or which is routine in nature. All items on the Common Consent Agenda are adopted by a single motion unless removed from the Common Consent Agenda).

1. Approval of the March 8th, 2023, Planning Commission minutes.

PUBLIC HEARINGS

1. Public hearing and recommendation on a proposed Land Use Map Amendment at approximately 96 North 350 West, on approximately 0.77 acres; changing the Land Use Map from Residential High Density to the General Commercial Land Use designation.
2. Public hearing and recommendation on a proposed Land Use Map Amendment for approximately 0.60 acres of land located at approximately 401 West Main Street, from Design Commercial to the General Commercial Land Use designation.
3. Public hearing and recommendation on a proposed Zone Change for approximately 0.60 acres of land located at approximately 401 West Main Street, from the R2-7500 Residential Zone to the Central Commercial (CC-2) Zone.

ACTION ITEMS

1. Review and action on a Site Plan application for the Perfect Dress Project, located at 424 West Main Street, in the Central Commercial (CC-2) Zone.
2. Review and action on an application for an accessory structure in excess of 1,000 square feet, located in the area of 33 East 100 North in the Residential (R4-7500) Zone.
3. Review and action on a Site Plan application for the Children's Justice Center Project, located at 96 S 100 E, in the Central Commercial (CC-1) Zone.

OTHER BUSINESS

1. Upcoming Projects

ADJOURNMENT

Dated this 9th day of March, 2023

Patrick O'Brien

Development Services Director

*The order of agenda items may change at the discretion of the Planning Commission Chairman

**AMERICAN FORK CITY
PLANNING COMMISSION REGULAR SESSION**

March 8, 2023

The American Fork City Planning Commission met in a regular session on March 8, 2023 at the American Fork City Hall, 31 North Church Street, commencing at 7:00 p.m.

Commissioners Present: Christine Anderson, Chris Christiansen, David Bird, Rodney Martin,

Absent: Jenny Peay, Harold Dudley, Bruce Frandsen

Staff Present:

Travis Van Ekelenburg	Senior Planner
Cody Opperman	Planner 1
Levi Burr	Engineer
Melissa White	Admin Assistant
Angela McKee	Admin Assistant

Others Present: David Thorne

REGULAR SESSION

Christine Anderson led the “Pledge of Allegiance”

Roll Call

COMMON CONSENT AGENDA

- 1. Minutes of the February 22, 2023 Planning Commission Regular Session.**

Chris Christiansen motioned to approve the minutes. David Bird seconded the motion.

Christine Anderson	AYE
Chris Christiansen	AYE
Rodney Martin	AYE
David Bird	AYE

PUBLIC HEARINGS

1. Public hearing and recommendation on a proposed amendment to American Fork City's Bike and Pedestrian Plan to update the plan for future pedestrian infrastructure throughout the City.

Cody Opperman reviewed the background information for public hearing item number 1: As the Design Industrial Land Use continues to expand in the south of the City more adjustments needed to be made towards pedestrian infrastructure. Eliminating and redirecting routes was necessary as there were inconsistencies with the General Plan and developments throughout the City. The proposed amendment to the masterplan will terminate part of the linear park trail and redirect it to other areas of the community. In addition, some other amendments are being proposed to address issues with previously planned trails and what was or was not implemented. The red areas indicate the abandonment of the pedestrian infrastructure, and the purple areas indicate the reroutes.

The Parks and Trails Committee has been presented with the concept and is supportive of the changes.

David Bird: Are the alternate routes following existing roads or are they separate paths not attached to the roads?

Cody Opperman: These will follow existing roads or roads we are proposing for the future. We are trying to ensure they follow the Master Transportation Plan as well.

David Bird: We are looking at the biking lane connected to the road?

Cody Opperman: Yes, as well as side paths and shared use paths and things like that. The difference between a side path is that it is for walking, and a shared use path also includes bike use and pedestrian walkways.

Mr. Martin thanked the Planning and Zoning department for their work.

Public Hearing Opened

No public comment

Public Hearing Closed

Rodney Martin motioned to recommend approval of the amendment to the American Fork General Plan, and to amend the American Fork City Bike and Pedestrian Plan.

Chris Christiansen seconded the motion. Voting was as follows:

Christine Anderson	AYE
Chris Christiansen	AYE
Rodney Martin	AYE
David Bird	AYE

The motion passed

- 2. Public hearing and recommendation on a proposed Land Use Map Amendment at approximately 9 W 1100 S, on approximately 4.35 acres; changing the Land Use Map from Residential Low Density to the Design Industrial Land Use designation.**

Cody Opperman reviewed the background information for public hearing item number 2: The applicant is applying for a land use map amendment for the property located at approximately 9 W 1100 S from the Residential Low-Density designation to the Design Industrial designation. There is one parcel with this request that consists of 4.35 acres in total.

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The proposed Design Industrial Land Use designation is being requested prior to an annexation for this property. It is currently unincorporated property. Staff recommends approval of this Land Use Map Amendment to continue to enhance planned industrial developments east of Boat Harbor Road.

Justification Statement from the applicant: *“With the recent expansion in ecommerce, the need for industrial office warehouse has increased dramatically. Utah County has continued to attract many large companies seeking office warehouse to expand their business.*

American Fork City has identified this area of the city as the correct location for expanded industrial development. With the recent construction of the Deer Park project adjacent to the parcel in question, we feel it makes sense to change the land use designation of this parcel from Residential Low Density to Design Industrial. Many of our prospective tenants have requested additional space for their business operations and our request is a result of their desire to expand.”

David Bird: This area is east of Boat Harbor Road and Industrial will be on the west side of the [Deer Park Industrial] property?

Cody Opperman: That is correct.

Rodney Martin: It fits within the use.

Public Hearing Opened

No public comment

Public Hearing Closed

David Bird motioned to recommend approval of the Land Use Map Amendment to Design Industrial, for the property located in the area of 9 W 1100 S, subject to any findings, conditions, and modifications found in the Staff Report.

Rodney Martin seconded the motion. Voting was as follows:

Christine Anderson	AYE
Chris Christiansen	AYE
Rodney Martin	AYE

David Bird

AYE

The motion passed

ACTION ITEMS

- 1. Review and action on an ordinance creating section 17.5.136 of the American Fork City Municipal Code relating to rock crushing and providing an effective date for the ordinance.**

Chairwoman Anderson noted that action item number 1 was pulled from the agenda.

- 2. Review and action on a Site Plan application for the Children's Justice Center Project, located at 96 S 100 E, in the Central Commercial (CC-1) Zone.**

Travis Van Ekelenburg reviewed the background information for action item number 2: The applicant is applying for Site Plan Approval for the Children's Justice Center, for the development of a justice center for children facing abuse, located at 96 South 100 East. The proposal consists of 1 parcel for a governmental structure and the entire development parcel consists of approximately 0.2 acres. The current site has been approved by City Council to have 6 parking stalls, but no Site Plan has been approved just yet. The Children's Justice Center Project has been brought back to Planning Commission because the previous Site Plan that was approved had seven parking stalls, now they are providing 6. Due to this Site Plan adjustment, it has been brought back to Planning Commission and will need a recommendation to their parking stalls for their final step of the Site Plan.

Rodney Martin: I would like to know what the use of the site is now such as the number of employees, who's going to be using this, etc. We already have problems in the city of someone coming in and using street parking because their employees don't have anywhere to park, nor do their customers. As much as we support the mission of the Children's Justice Center.

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Heather Allen: I'm the Associate Director of the Children's Justice Center. Yes, the location will still be used for the Children's Justice Center. It is a facility where clients will come in and be there for approximately two hours. There's a common misconception that we house people and that's not the case. We have regular business hours from eight to five, typically, unless any of our interviews run a little bit longer and it is Monday through Friday. Very rarely we will be there on weekends, but that is if we have an urgent need for a child. We have six employees total, but half of them are part-time. It's typically three or four employees a day. At the moment we're just seeing one family at a time, because we don't want to overlap for confidentiality.

Rodney Martin: With the number of people you have employed there while seeing one client - which would possibly include both parents, a caseworker, and a parent or foster parent - you're maxed out on your parking. You can't accept any more with six stalls. I came in late on this, but how did we get to six stalls being sufficient?

David Thorne: I'm the general contractor on site. Part of the due diligence that we did on this was having a parking study done. They studied the Children's Justice Center at their current location [in Provo, UT], on their busiest day of the week, and they studied the comings and goings of employees and clients. They came in with a recommendation of four parking stalls for the Children's Justice Center. That's how we got a reduction down to six stalls. It was seven originally, but six through the City Council. 14 stalls is physically impossible to get on the site without ripping down the original 1871 home. That is a challenge that we're trying to work through. We got down to seven, but we didn't realize exactly what the challenges were. There were some comments at the last Planning Commission meeting that stated that we were supposed to make some revisions. We weren't sure what they were when the Planning Commission voted. The day after, we found out that they wanted us to re-do the whole site plan that was approved by the last Planning Commission to accommodate the seven stalls because of some safety concerns with the angled stalls on 100 East. If we had known those issues, we would have probably requested six at the original Planning Commission meeting so that we didn't have to put stalls on site. That's why we requested six at City Council. We're still over by two stalls of the recommended through the parking study. We will not have angled parking on 100 East, but we will have one single stall that is parallel, four parallel stalls on 400 South, and one handicap stall on site. There is angled parking in front of the library that we need to turn to parallel.

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We're so close to the corner that there were safety concerns and we wanted to accommodate the safety concerns.

David Bird: What are the prospects of needing to expand your facility? Currently you say that you are dealing with one family at a time. In the future would you expand to have two or three or more? If that is a possibility, it would put more pressure on the parking situation.

Heather Allen: That is not something we've been able to evaluate yet because we're still trying to figure out this parking situation and what the new building will be capable of handling. My dream scenario would be to buy the property behind us and we can keep growing. Right now with the current house we do not know. We have been in conversations with the Church of Jesus Christ of Latter Day Saints to use some of the parking that's behind the church as there is an entrance that is diagonal from where the building is located. It is a short distance and my staff and I would be fine walking that short distance. It has not been solidified with the church, but it looks like we are going to have an ongoing agreement with them that we would renew periodically.

Rodney Martin: Can any of the Commissioners shed light on the situation or what has happened previously. I still feel uncomfortable with the parking situation, am I out of line in feeling that way?

Travis Van Ekelenburg: They originally submitted several site plans. We looked at the feasible options on the property, and the Planning Commission wanted to approve the site plan that was originally here [with 14 stalls]. City Council reduced it to six stalls so it's coming back to you with a revised site plan. Since it's in the CC-1 zone, the Planning Commission is the approval body for the site plan, and then you give a recommendation of approval for the support of the City Council's decision on the number of parking stalls.

Rodney Martin: This doesn't conflict with any zoning or any other requirements in the city just because they are the Children's Justice Center?

Chris Christiansen: Part of this was the historical nature of the building. I know the covered porch was brought up which potentially creates more stalls there, but again, preserving the [historical nature of the building was considered important]. I think there were grading issues that were talked about as well. We were okay with seven stalls at that point.

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David Thorne: The only difference of the site plan that was approved by the last Planning Commission and the site plan that is before you today is a reduction of one stall. It went from two angled stalls that were approved to just one parallel stall. That's the only difference, and it was to account for safety in the site triangles.

Chris Christiansen motioned to approve the site plan and recommend the reduction of parking stalls to six stalls, for the redevelopment of a property for use as the Children's Justice Center, located at 96 South 100 East, in the CC-1 zone, subject to any conditions found in the Staff Report and recommended by the Fire Marshall.

David Bird seconded the motion. Voting was as follows:

Christine Anderson	AYE
Chris Christiansen	AYE
Rodney Martin	NAY
David Bird	AYE

The motion did not pass

Rodney Martin: I may be in the minority, but I see problems. Our city is growing. The need for these kinds of services is growing. It may be the case that this historical building that we all love is not the place for the Children's Justice Center and they need to find somewhere else that more suitable for the services they provide and are going to provide in the future.

David Bird: I think that building is one that should be preserved. I think using it for the Children's Justice Center gives the new occupants the opportunity to revive, revitalize, and improve, and to bring the standards up to code. Currently, they have one family at a time and minimal employees there. I don't see it as a problem. Five years down the road there may be two families or three families, but we've never approved anything based on what might happen five years down the road. I see it as a good use of this building. [The building] could otherwise potentially fall into disrepair. I hate to see a solid, legitimate use locked on account of a couple of parking spaces that can be accommodated with the tabernacle. That's why I think it would be a good addition.

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Rodney Martin: With all due respect, we do vote on things based on what the future is likely to bring. We base our road width based on what we expect the build-out to be, and things like that. We plan for the future. I for one don't want to be the Commission that approves something that is going to be a major headache and cause people to complain and say, "How could they possibly approve this? This is so short-sighted." I'm not comfortable with it.

Heather Allen: As far as being able to move, if I could have, I would have. I bought this home in November of 2020 and we have had a lot of roller coaster ups and downs trying to make this house happen. The first time I walked through it I felt in my heart that it was the place that the CJC was supposed to be. We try to have a home-like environment so that the children feel comfortable and safe. When I walked through it, it felt like it was supposed to be the CJC. Well, we had issue after issue, especially before we started working with David. The home was purchased with funds that were from a CDBG (Community Development Block Grant). Because the previous contractor had started doing things to the home, we would have to repay that money to CDBG. There's no way that we could recoup that money at this point.

Chairwoman Anderson: Given the size of the house, would it be possible to serve two different families at the same time?

Heather Allen: Yes and no. Because of the office space there's not really a way for us to expand our employees; it already has the max number of offices that we can possibly have, so having more employees is not feasible. As it stands right now there's not really the space to have two families there at the same time while protecting confidentiality. We are not at the stage of the building plans yet, so it's hard to say for sure without knowing what is possible to do with the house and how many people it is capable of holding. Yes, if in the future we could serve more than one family [it would be ideal], because that's what the Provo center is currently doing. But they have a much larger building and have three times the employees, so it is hard to predict.

David Bird: Mr. Martin, is your main concern the parking situation?

Rodney Martin: Yes, and using on-street parking. I know we have approved on-street parking to count towards the total number of stalls in this area here, and around City Hall for the Harrington. However, I have a hard time feeling

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comfortable with this because the downtown area is going to change and grow as we move towards high-density. I don't believe in flooding our streets during office hours. Yes, 14 stalls seem like too many based on the Children's Justice Center's use, but 14 stalls to 6 stalls is a huge reduction.

Chairwoman Anderson: I think is worth considering that if one of the cars parked at this facility is not handicapped then there are only five spots. I wonder if we could get formal acceptance from the location across the street to allow [for additional parking], and if that will make a difference.

Travis Van Ekelenburg: We don't have anything like that for parking agreements that aren't contiguous to the property itself, which means there is nothing the city can do in that regard.

David Bird: I can see your concern, Mr. Martin. I have to vacillate between [the parking concern] and the use of the building. I think it is a just and good use for the building. The area around it is pretty much filled in, and I would not anticipate a lot of growth in the immediate area around it. It is an older section of town and pretty well-established, and there is not a lot of vacant area to build high-density housing.

Rodney Martin: To the north is the parking lot for the American Fork library. To the west of the library is Humphries [Welding Supply] which takes up most of the block for their warehousing, etc. When Humphries leaves, the entire middle of that block is going to be set up for future development. There are numerous older homes that are going to be torn down eventually and replaced with other buildings, etc. As much as I love the mission of the Children's Justice Center, I don't know that that is a good enough reason to brush aside the fact that there is not enough parking. Yes, they can use the angled parking in front of the library or the library parking lot. However, who they are should not exempt them from reasonable requirements.

Chris Christiansen: I don't necessarily think it's because of who they are. It's evaluated on the current use of the property, the requirements, and the traffic that's going through. They will have to work within the zoning of whatever that future use is. But for me, it's not about who they are as much as the demand for that area that is going to make an impact now. If you were to turn this into a convenience store, then there would be a lot more traffic. However, I don't think that is going to

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be the future use that we would see there. I think it's great to have differing views on this. However, because we're limited to four Commissioners here tonight, I'd like to make a recommendation that respects both parties.

Chairwoman Anderson: I do not want anyone to feel as though they must come to a unanimous decision if they do not agree with the decision.

Rodney Martin: I'm not trying to be an obstructionist. I understand that the Planning Department has signed off on this, and the previous Planning Commission meeting signed off on this with one more parking space. In my opinion, putting the burden on street parking is tough.

Travis Van Ekelburg: As a reminder, the City Council did approve six stalls.

Chris Christiansen: This item was at this Commission approximately two months ago and it was this Commission that approved [seven stalls].

David Thorne: Hales Engineering did a full report, and it should be included in what was submitted in the parking study. You're welcome to read their recommendation. As I understand it, the use is for government use. If anything was to ever change out of government use, then the parking requirements don't stay at six [stalls]. If they were to sell the building in the future and it goes to somebody else, it goes back to the 14 stall requirement.

Travis Van Ekelburg: Any new use to come into the building would have to adhere to whatever those parking requirements would be.

David Bird: Any variances allowed now would be rescinded if the building sold?

Travis Van Ekelburg: Correct. Just like any other building that's vacated, if another use comes in it has to adhere to that use and meet current requirements.

Rodney Martin: I wish we had more Commissioners tonight to make this decision.

David Bird: Perhaps we should table it until we have more Commissioners to vote.

Chris Christiansen motioned to table action on the site plan and parking reduction request for the redevelopment of a property for use as the

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Children's Justice Center, located at 96 South 100 East, in the CC-1 zone until the Planning Commission has a fuller quorum.

Rodney Martin seconded the motion. Voting was as follows:

Christine Anderson	AYE
Chris Christiansen	AYE
Rodney Martin	AYE
David Bird	AYE

The motion was tabled.

OTHER BUSINESS

Cody Opperman: We are staying busy and continuing to see a lot of developments come through our process. We're kicking off our Station Area Plan and will have our first meeting tomorrow. The Station Area Plan is a requirement from the state, and it also helps with one of our goals that we have set in the Moderate Income Housing Plan as well. It's in the vicinity of our TOD zone. We're still getting some annexations and we're continuing to grow south of I-15.

Upcoming Projects

ADJOURNMENT

David Bird motioned to adjourn the meeting. Chris Christiansen seconded the motion.

Meeting adjourned at 7:37 PM

Melissa White

Administrative Assistant

The order of agenda items may change to accommodate the needs of the commissioners, public and staff.

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AGENDA TOPIC:

Public hearing and recommendation on a proposed Land Use Map Amendment for property located at approximately 96 N 350 W, from the Residential High Density to the General Commercial Land Use designation.

BACKGROUND INFORMATION		
Location:		96 North 350 West
Applicants:		ABE Properties, LLC
Existing Land Use:		Residential High Density
Proposed Land Use:		General Commercial
Surrounding Land Use:	North	Residential High Density
	South	Residential High Density
	East	Residential High Density
	West	Residential High Density
Existing Zoning:		R3-7500
Proposed Zoning:		N/A
Surrounding Zoning:	North	R3-7500
	South	R3-7500
	East	R3-7500
	West	R3-7500

BACKGROUND:

The applicant is applying for a Land Use Map Amendment for property located at approximately 96 N 350 W, from Residential High Density to General Commercial land use designation. All parcels consist of 0.77 acres.

The subject property was previously on the regularly scheduled Planning Commission meeting on February 8, 2023, and received a positive recommendation to the City Council for the CC-2 Zoning designation. On February 28, 2023 the same application was before the City Council and passed with the condition that the Land Use Designation would need to be changed for the Zone Change to be finalized.

POTENTIAL MOTIONS – Land Use Map Amendment

APPROVAL

I move that we recommend approval of the Land Use Map Amendment from Residential High Density to General Commercial, for the properties located in the area of 96 N 350 W, subject to any findings, conditions, and modifications found in the Staff Report, or recommended by the Fire Marshal.

DENIAL

I move that we deny of the Land Use Map Amendment from Residential High Density to General Commercial, for the properties located in the area of 96 N 350 W, with a finding that the proposed Land Use is not contiguous to the adjacent properties.

TABLE

I move that we table action on the Land Use Map Amendment from Residential High Density to General Commercial, for the properties located in the area of 96 N 350 W, and instruct the developer/staff to _____.

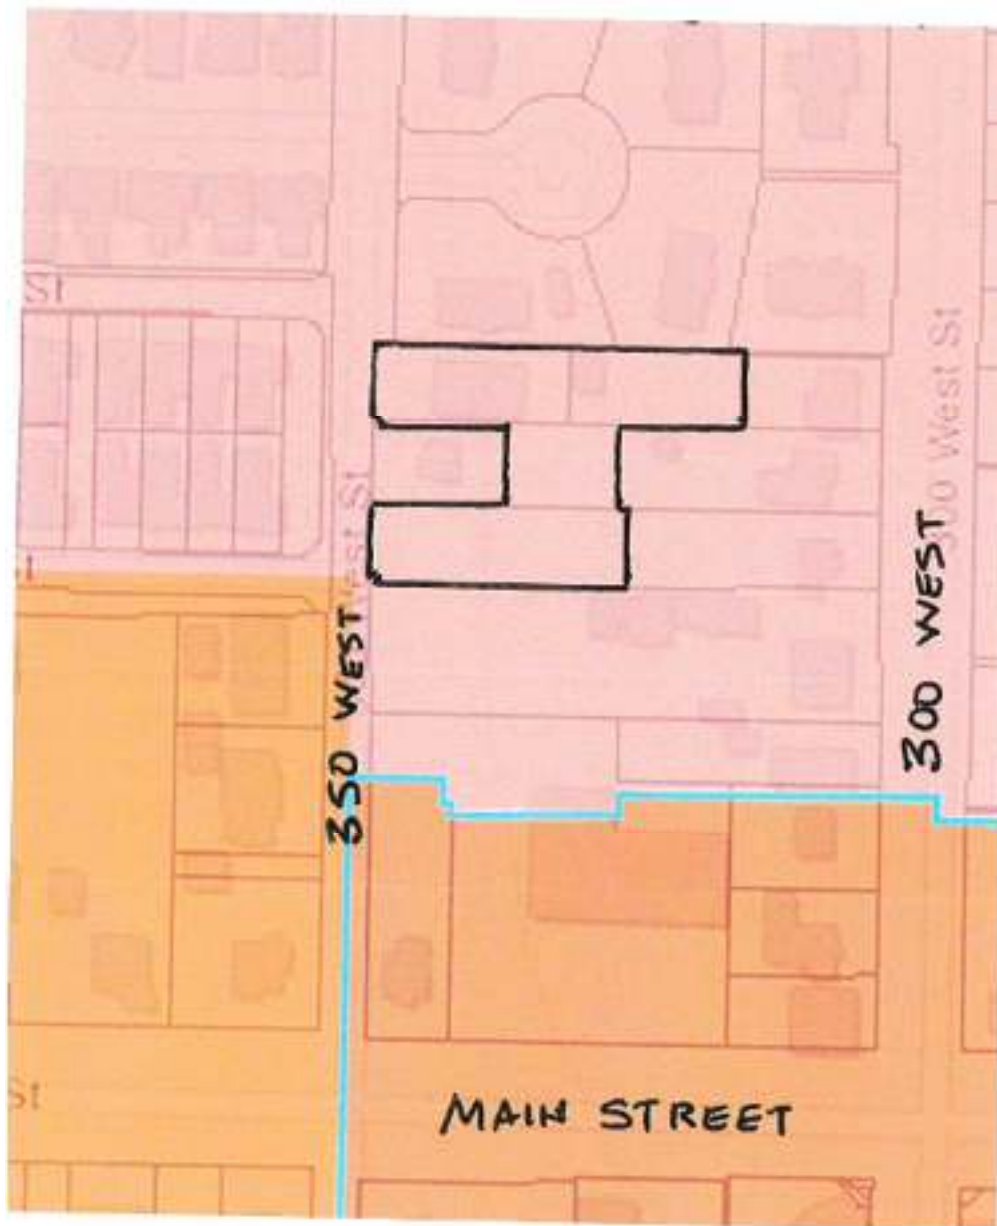


Figure 1. Land Use Types.

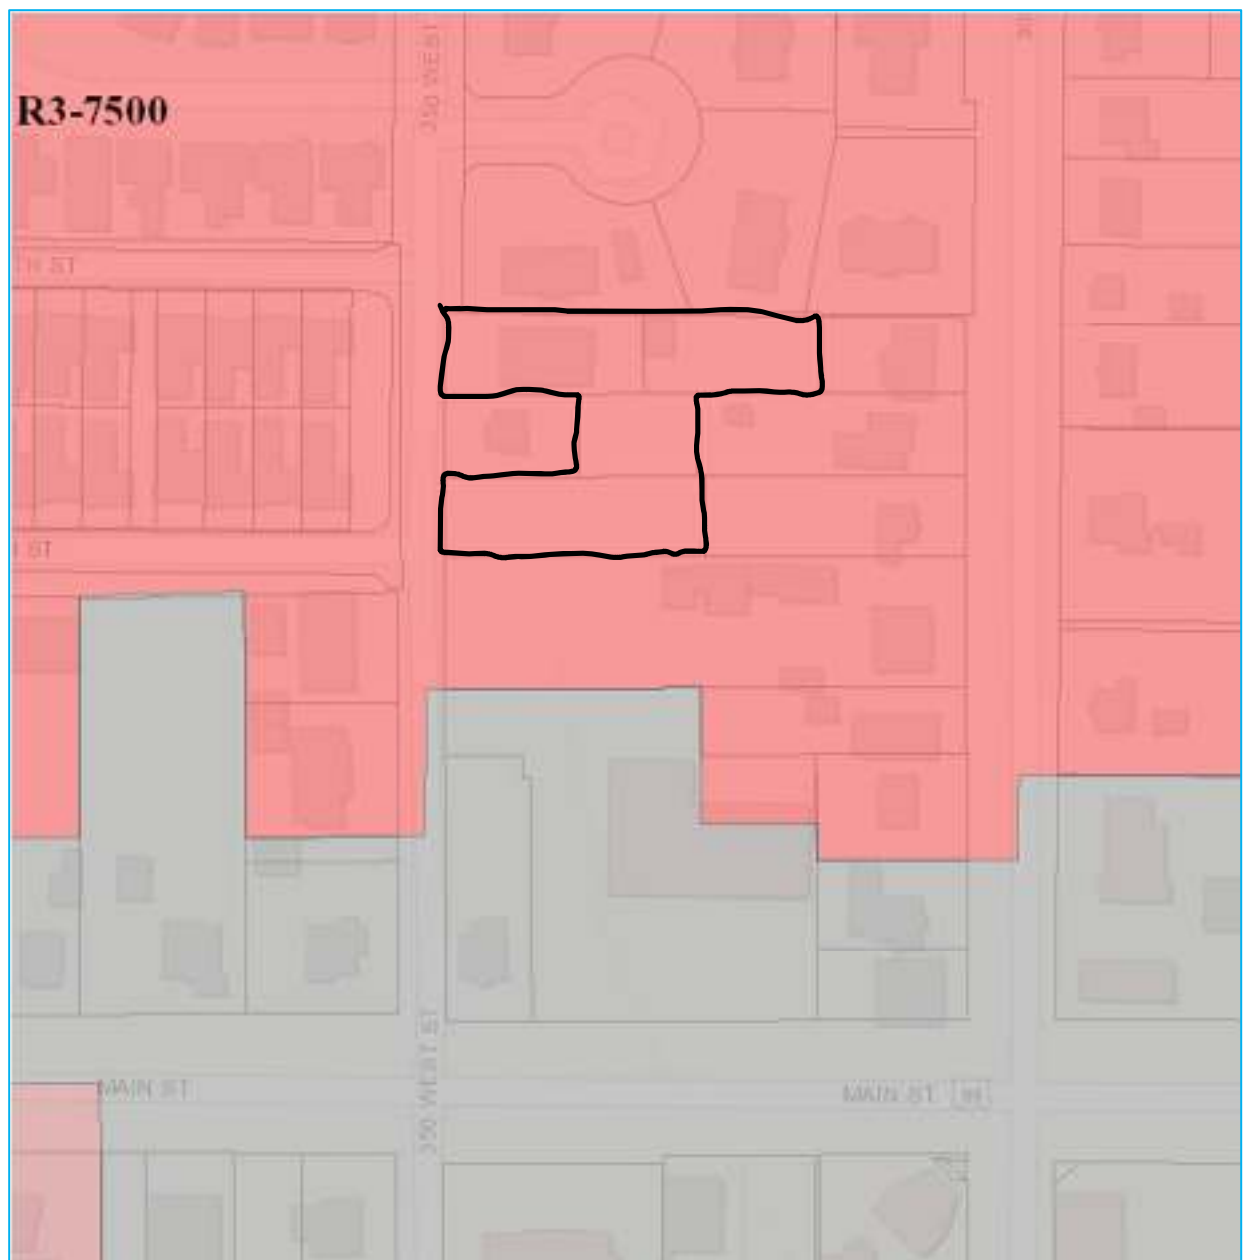


Figure 2. Zoning Types.



LAND USE MAP AMENDMENT APPLICATION
01 MAR 2023
PROPERTY LOCATED ON 350 WEST
OWNED BY ABE PROPERTIES

JUSTIFICATION FOR CHANGE AND CHANGING CONDITIONS.

1. LAND USE MAP NEEDS TO MATCH PROPOSED ZONE CHANGE.
2. ZONE CHANGE REQUESTED BY OWNER FOR FOUR SMALL PARCELS TO BE USED FOR OFFICE BUILDING AND MORE PARKING FOR THEATER.
3. EXISTING BUILDING ON SITE IS CURRENTLY A THEATER/SPECIALTY SCHOOL. THIS CHANGE WILL BRING THE BUILDING USE INTO COMPLIANCE.
4. CITY COUNCIL REQUESTED THAT THIS APPLICATION ACCOMPANY THE ZONE CHANGE APPLICATION.
5. MORE CC-2 ZONE IS NEEDED TO ACCOMMODATE NUMEROUS SMALL BUSINESSES THAT ARE ANTICIPATED.
6. APPLICANT OWNS 4 SMALL PARCELS TO BE COMBINED FOR ONE SITE PLAN.



AGENDA TOPIC:

Public hearing and recommendation on a proposed Land Use Map Amendment for approximately 0.60 acres of land located at approximately 401 West Main Street, from Design Commercial to the General Commercial Land Use designation.

BACKGROUND INFORMATION		
Location:		401 West Main Street
Applicants:		The Smith Family Trust 07-02-2012; Aaron Drussel
Existing Land Use:		Design Commercial
Proposed Land Use:		General Commercial
Surrounding Land Use:	North	Design Commercial
	South	Residential Medium Density
	East	Design Commercial
	West	Design Commercial
Existing Zoning:		R2-7500
Proposed Zoning:		N/A
Surrounding Zoning:	North	CC-2
	South	R2-7500
	East	CC-2
	West	CC-2

BACKGROUND:

The applicant is applying for a Land Use Map Amendment for the property located at approximately 401 West Main Street, from Design Commercial to the General Commercial land use designation. The entire parcel consists of 0.60 acres.

The General Commercial Land Use is applicable to the traditional commercial area of the City, which would include the Central Business District and areas in the vicinity of State Street and other major travel corridors currently designated for commercial purposes. As the property is fronting Main Street, a major travel corridor, the General Commercial Land Use designation would be applicable.

The applicant has provided a Zone Change application that is running concurrently with this Land Use Map Amendment. The Zone that they are proposing is the CC-2 zone. With

the CC-2 Zone Change proposal the Design Commercial Land Use would not be an appropriate fit as it is commonly used for shopping-center type of developments. One of the CC-2 Zone's intent is to facilitate the orderly development of property within and adjacent to the built-up central business area of the City for commercial purposes but to do so in a manner to minimize the adverse impacts of such commercial activity on existing residents and residential uses in the zone area.

As the Design Commercial Land Use is used for planned shopping-center type of developments and in areas which are being newly developed, the General Commercial Land Use would be more appropriate for this property fronting Main Street.

POTENTIAL MOTIONS – Land Use Map Amendment

APPROVAL

I move that we recommend approval of the Land Use Map Amendment for approximately 0.60 acres of land, located at approximately 401 West Main Street, from Design Commercial to the General Commercial Land Use designation, subject to any findings, conditions, and modifications found in the Staff Report, or recommended by the Fire Marshal.

DENIAL

I move that we deny of the Land Use Map Amendment for approximately 0.60 acres of land, located at approximately 401 West Main Street, from Design Commercial to the General Commercial Land Use designation.

TABLE

I move that we table action on the Land Use Map Amendment for approximately 0.60 acres of land, located at approximately 401 West Main Street, from Design Commercial to the General Commercial Land Use designation, and instruct the developer/staff to

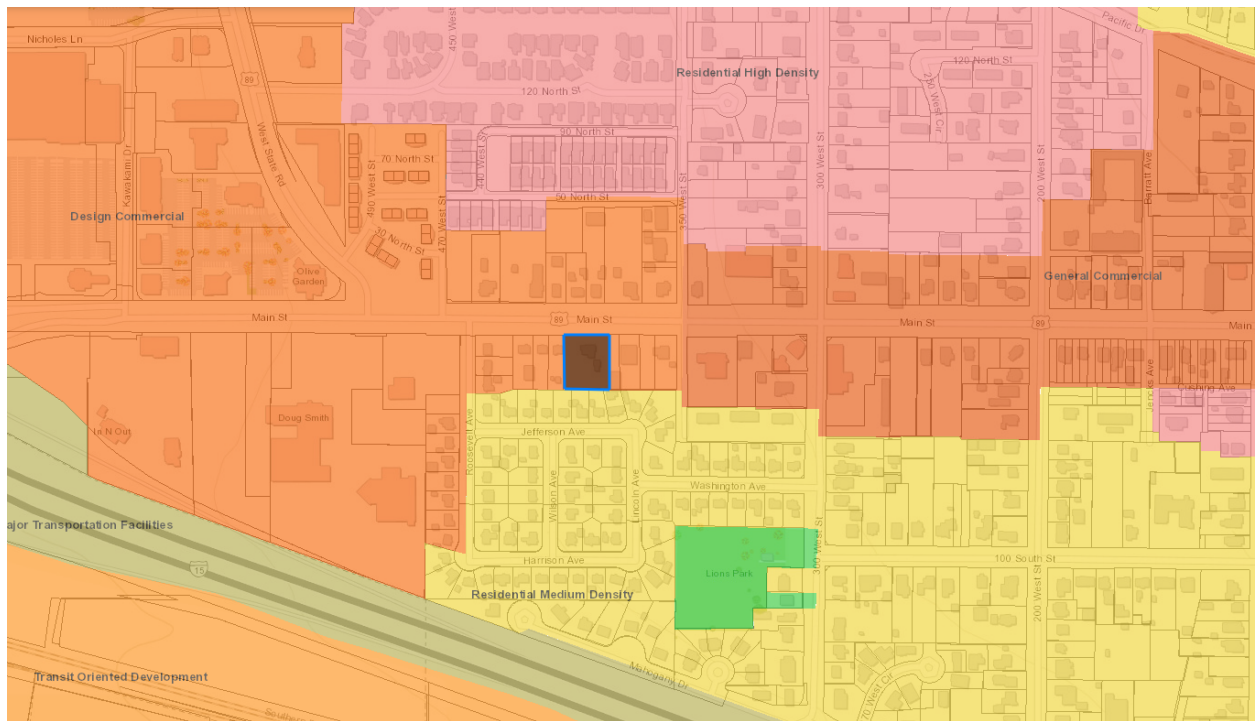


Figure 1. Land Use Types.

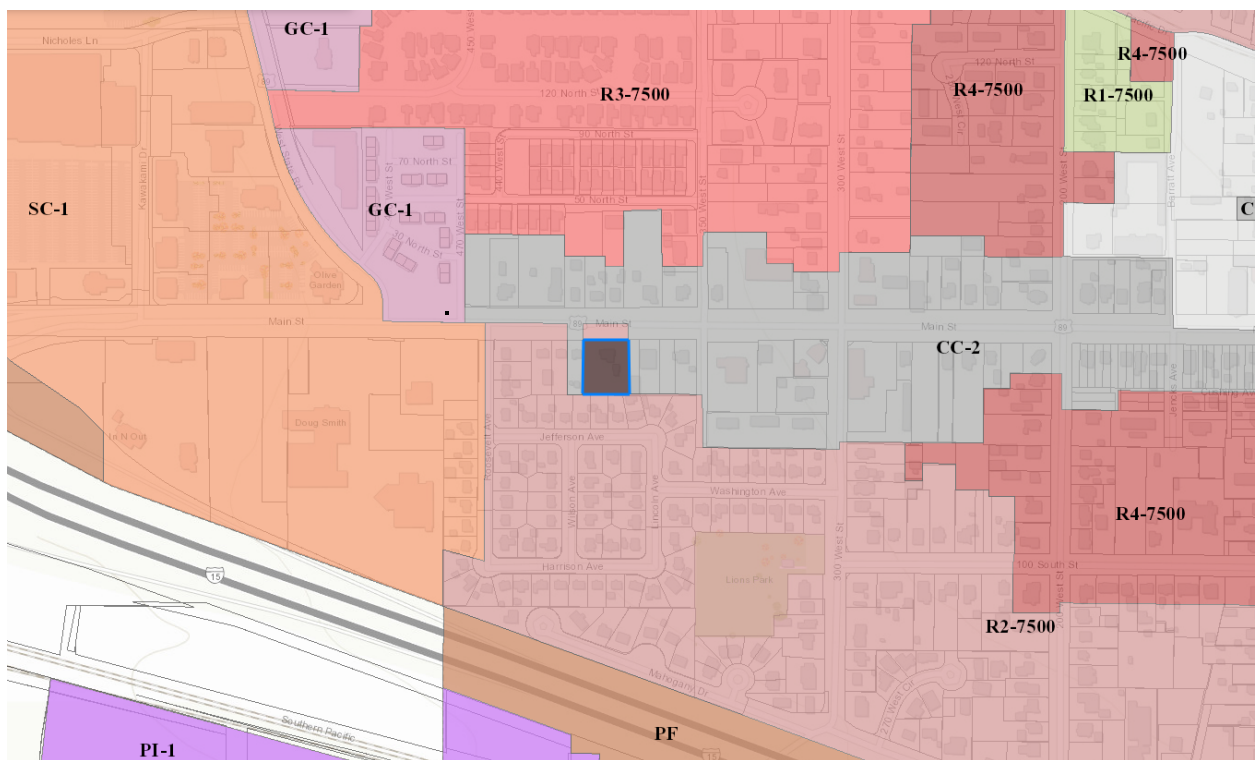


Figure 2. Zoning Types.

AGENDA TOPIC:

Public hearing and recommendation on a proposed Zone Change for approximately 0.60 acres of land located at approximately 401 West Main Street, from the R2-7500 Residential Zone to the Central Commercial (CC-2) Zone.

BACKGROUND INFORMATION		
Location:		401 West Main Street
Applicants:		The Smith Family Trust 07-02-2012; Aaron Drussel
Existing Land Use:		Design Commercial
Proposed Land Use:		N/A
Surrounding Land Use:	North	Design Commercial
	South	Residential Medium Density
	East	Design Commercial
	West	Design Commercial
Existing Zoning:		R2-7500
Proposed Zoning:		CC-2
Surrounding Zoning:	North	CC-2
	South	R2-7500
	East	CC-2
	West	CC-2

BACKGROUND:

The applicant is applying for a Zone Change for the property located at approximately 401 West Main Street, from the R2-7500 Residential Zone to the Central Commercial (CC-2) Zone. The entire parcel consists of 0.60 acres.

One of the CC-2 Zone's intent is to facilitate the orderly development of property within and adjacent to the built-up central business area of the City for commercial purposes but to do so in a manner to minimize the adverse impacts of such commercial activity on existing residents and residential uses in the zone area.

POTENTIAL MOTIONS – Land Use Map Amendment

APPROVAL

I move that we recommend approval of the Zone Change for approximately 0.60 acres of land, located at approximately 401 West Main Street, from the R2-7500 Residential Zone to the Central Commercial (CC-2) Zone, subject to any findings, conditions, and modifications found in the Staff Report, or recommended by the Fire Marshal.

DENIAL

I move that we deny of the Zone Change for approximately 0.60 acres of land, located at approximately 401 West Main Street, from the R2-7500 Residential Zone to the Central Commercial (CC-2) Zone.

TABLE

I move that we table action on the Zone Change for approximately 0.60 acres of land, located at approximately 401 West Main Street, from the R2-7500 Residential Zone to the Central Commercial (CC-2) Zone, and instruct the developer/staff to

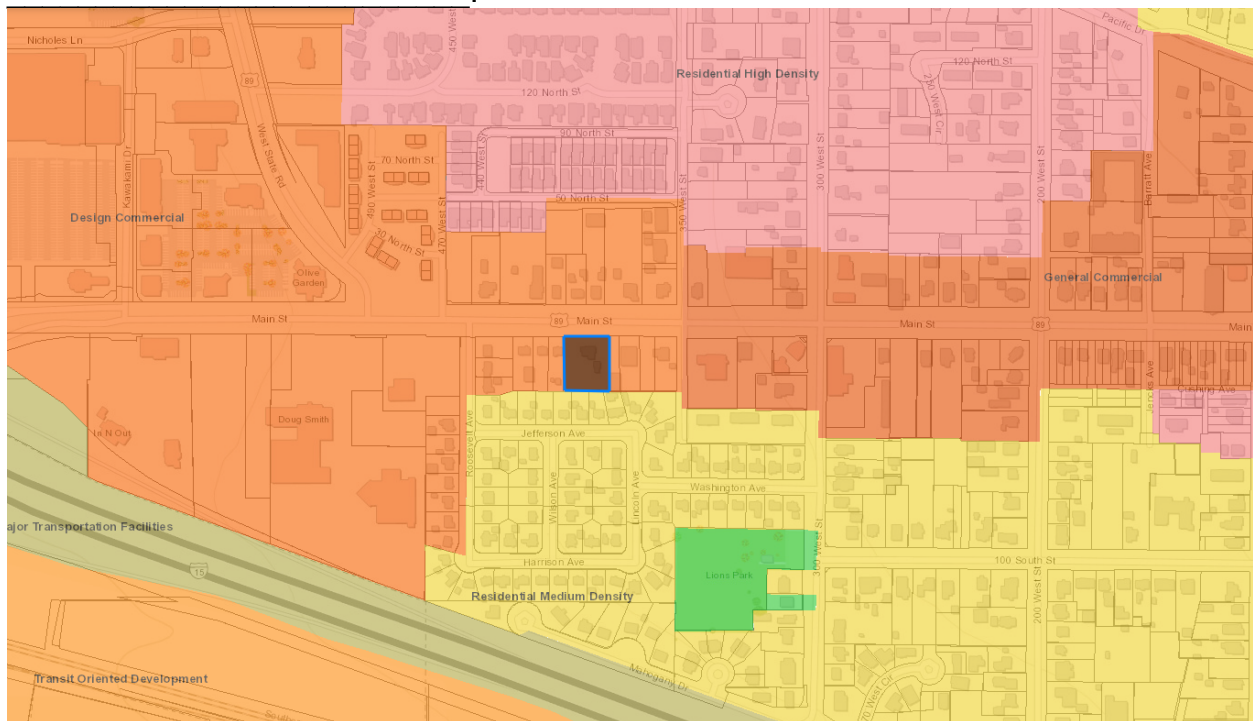


Figure 1. Land Use Types.


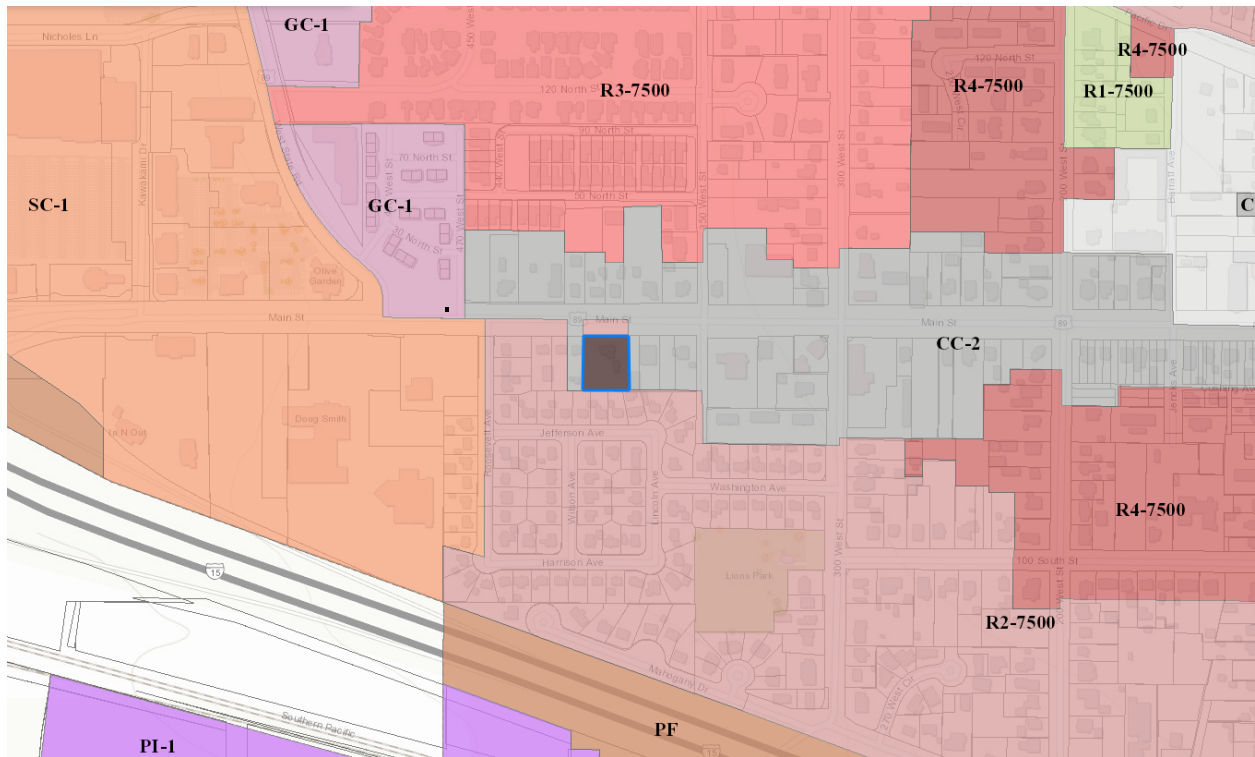


Figure 2. Zoning Types.



► Measurement

+ -

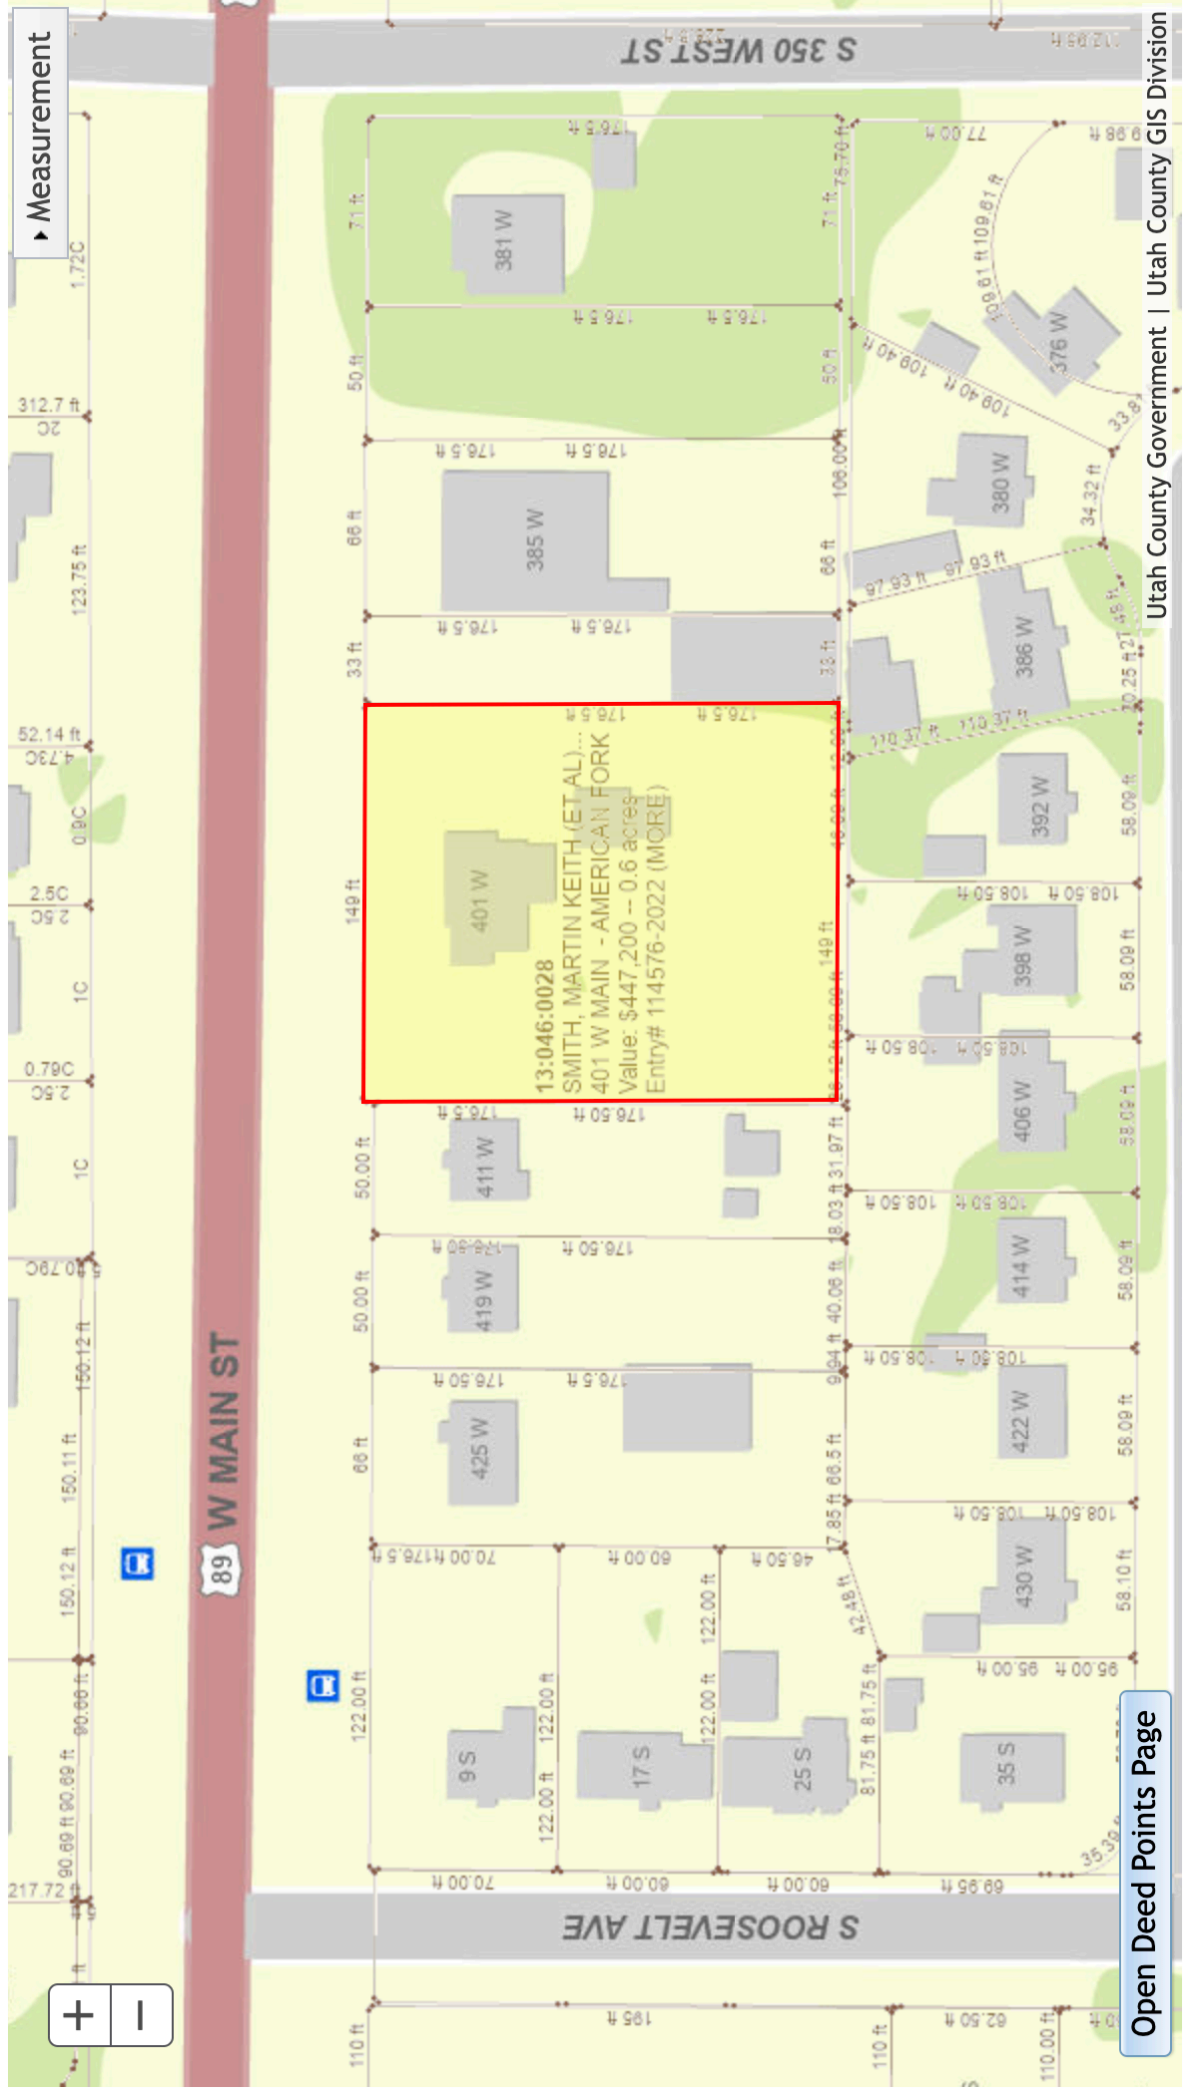

89 W MAIN ST

S ROOSEVELT AVE

S 350 WEST ST

Open Deed Points Page

Utah County Government | Utah County GIS Division

**AMERICAN FORK CITY
PLANNING COMMISSION STAFF REPORT**

MEETING DATE: March 22, 2023

AGENDA TOPIC:

Review and action on a Site Plan application for the Perfect Dress Project, located at 424 West Main Street, in the Central Commercial (CC-2) Zone.

BACKGROUND INFORMATION		
Location:		424 West Main Street
Project Type:		Site Plan
Applicants:		Dunn Davis Properties, LLC; TJ Davis
Existing Land Use:		Design Commercial
Proposed Land Use:		N/A
Surrounding Land Use:	North	Residential High Density
	South	Design Commercial
	East	Design Commercial
	West	Design Commercial
Existing Zoning:		CC-2
Proposed Zoning:		N/A
Surrounding Zoning:	North	R3-7500
	South	R2-7500
	East	CC-2
	West	CC-2

BACKGROUND:

The applicant is applying for Site Plan Approval for the Perfect Dress, for an improvement of a parking lot, located at 424 West Main Street. The proposal consists of 1 parcel for a parking lot and interior renovation of an existing building, the entire development parcel consists of approximately 0.80 acres. This has been brought to Planning Commission for a recommendation to City Council for their improvements to the parking lot.

Sec 17.6.101 Administrative Site Plan Review

Wherever the terms of this code require submission and approval of a site plan, such review shall be conducted in accordance with the following provisions.

1. Planning commission to approve. The planning commission, acting in an administrative capacity, shall have the function, duty and power to approve or disapprove a project plan and to attach such modifications or conditions as may be deemed appropriate to improve the layout, to ensure that the project will not pose any detrimental effect to persons or property, or to protect the health, safety, and general welfare of the citizens of the city.
2. Application required. Application for site plan approval shall be submitted on forms provided by the city and shall be accompanied by maps and drawings showing the following:
 1. The location of all existing and proposed buildings and structures on the site, with full dimensions showing the distance between buildings and distances from buildings to adjacent property lines.
 2. The location of all parking spaces, driveways, and points of vehicular ingress and egress.
 3. A landscaping plan showing the location, types, and initial sizes of all planting materials to be used together with the location of fences, walls, hedges, and decorative materials.
 4. Preliminary elevations of main buildings showing the general appearance and types of external materials to be used.
 5. The locations of solid waste receptacles and trash pick-up areas.
3. Appeals permitted. Any person aggrieved by a determination of the planning commission may request a hearing before the city council who shall have the authority to reverse, affirm or modify any decision of said commission. Any such appeal shall be filed within ten days of the determination of the planning commission.
4. Issuance of a permit. A building permit shall not be issued for any building or structure or external alterations thereto until the provisions of this section have been complied with. Any construction not in conformance with an approved site plan shall be considered a violation of this code. Any building permit issued shall ensure that development is undertaken and completed in conformity with the plans as approved.

PROJECT MAP:



PROJECT CONDITIONS OF APPROVAL:

1. N/A

FINDINGS OF FACT:

- The application meets the requirements of Section 17.6.101

STANDARD CONDITIONS OF APPROVAL:

APPLICANT is responsible and shall submit/post/obtain all necessary documentation and evidence to comply with these Standard Conditions of Approval prior to any platting, permitting, or any other form of authorization by the City including plat recording or other property conveyance to the City and prior to scheduling a pre-construction meeting. All recording shall take place at the Utah County Recorder's Office.

1. **Title Report:** Submit an updated Title Report not older than 30 days or other type of appropriate verification that shows all dedications to the City are free and clear of encumbrances, taxes, or other assessments.
2. **Property Taxes and Liens:** Submit evidence that all the property taxes, for the current and/or previous years, liens, and agricultural land use roll over fees have been paid in full.

3. **Water Rights:** Submit evidence that all the required water rights have been conveyed to American Fork City.
4. **Performance Guarantee:** Post a performance guarantee for all required public and essential common improvements.
5. **Easements and Agreements:** Submit/record a long-term Storm Water Pollution Prevention Maintenance Agreement signed and dated by the property owner and any required easement documentation.
6. **Land Disturbance Permit:** Obtain a Land Disturbance Permit.
7. **Compliance with the Plan Review Comments:** All plans and documents shall comply with all the Technical Review Committee comments and the City Engineer's final review.
8. **Commercial Structure:** Record an Owner Acknowledgment and Utility Liability Indemnification if the proposed building is a multi-unit commercial structure served by a single utility service.
9. **Sensitive Lands:** Record all applicable documents required for compliance with the City's Sensitive Lands Ordinance.
10. **Utility Notification Form:** Submit a Subdivision Utility Notification Form.
11. **Professional Verification:** Submit final stamped construction documentation by all appropriate professionals.
12. **Fees:** Payment of all development, inspection, recording, streetlight, and other project related fees.
13. **Mylar:** Submit a Mylar. All plats will receive final verification of all formats, notes, conveyances, and other items contained on the plat by City staff (recorder, legal, engineer, GIS, planning).

STAFF RECOMMENDATION:

The Site Plan application meets the requirements of Section 17.6.101 and staff recommends APPROVING the application.

POTENTIAL MOTIONS – Site Plan

APPROVAL

I move that we approve the Site Plan application for the Perfect Dress Project, located at 424 West Main Street, in the Central Commercial (CC-2) Zone, subject to any conditions found in the Staff Report and recommended by the Fire Marshall.

DENIAL

I move that we deny the Site Plan application for the Perfect Dress Project, located at 424 West Main Street, in the Central Commercial (CC-2) Zone.

TABLE


I move that we table action on the Site Plan application for the Perfect Dress Project, located at 424 West Main Street, in the Central Commercial (CC-2) Zone, and instruct the developer/staff to _____.

U.S. Standard Units
(Inch-Pound Units)

ALL UNITS IN FEET UNLESS
OTHERWISE NOTED

THE PERFECT DRESS PARKING LOT

424 WEST MAIN STREET
AMERICAN FORK, UT
22-100-307-00

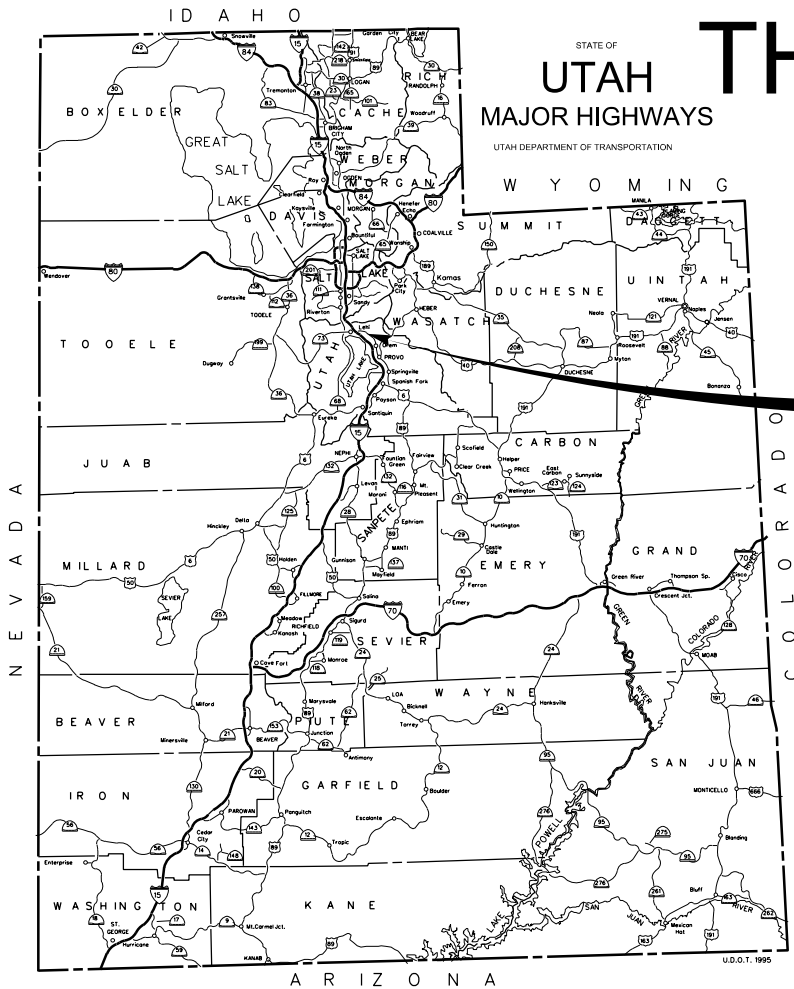

PROJECT LOCATION

AMERICAN FORK UTILITY CONTACTS

CULINARY WATER/P.I.
SEWER/STORM DRAIN
CITY INSPECTOR
SWPPP INSPECTOR
AMERICAN FORK FIRE MARSHAL
T.S.S.D.
AMERICAN FORK IRRIGATION COMPANY
MITCHELL HOLLOW IRRIGATION CO.
ROCKY MOUNTAIN POWER
COMCAST
CENTURY LINK
AMERICAN FORK FIBER
DOMINION ENERGY

JAY BREMS (801)763-3060
ASHTON HARDY (801)763-3060
DEE HOWARD (801)763-3060
HARLAN NIELSON (801)763-3060
MAT SACCO (801)763-3045
DAVID BARLOW (801)756-5231
ERNIE JOHN (801)471-6576
DALE JONES (801)768-8150
TERIA WALKER (801)756-1310
ELYSIA VALDEZ (801)401-3017
BILL WESTFALL (435)623-4252
KYLE PETERSON (801)400-2933
TRENT JOHNSON (801)853-6548

No comments



American Fork City
Development Review
Committee

Planning and Zoning
Reviewed
Copperman 03/14/2023

Fire Department
Reviewed
M. Sacco 03/15/2023


Engineering Division
Reviewed
jhsu 03/15/2023




INDEX TO SHEETS

SHEET NUMBER	# OF SHEETS	SHEET TITLE
1	1	TITLE & INDEX TO SHEETS
TS-01	1	TYPICAL SECTION
RD-01	1	ROADWAY
RD-02	1	ADA RAMP AND SIGN DETAILS
UT-01	1	UTILITY
DT-01 TO DT-02	2	ROADWAY DETAIL
GR-01 TO GR-02	2	GRADING

FEMA FLOOD ZONE
FEMA FIRM MAP 49049C0168F
EFFECTIVE 6/19/2020
NO FLOODWAY DELINATED AT PROJECT LOCATION

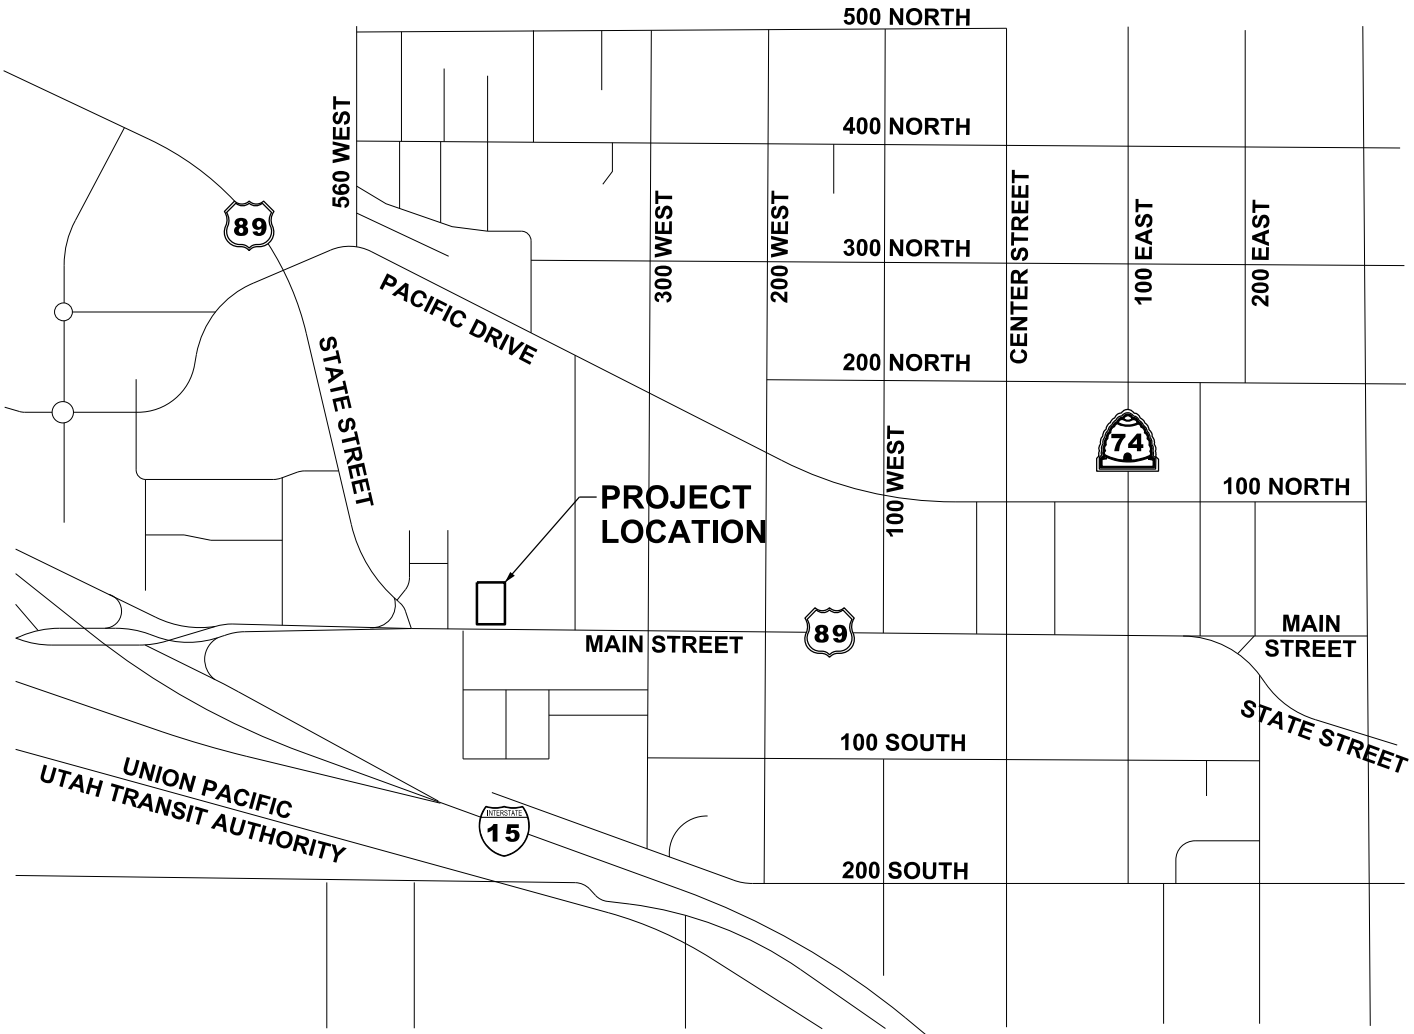

THIS SEAL APPLIES TO ALL SHEETS
CONTAINING THIS SIGNATURE

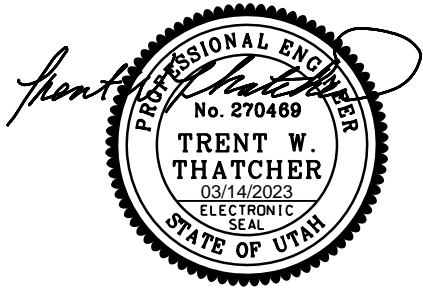


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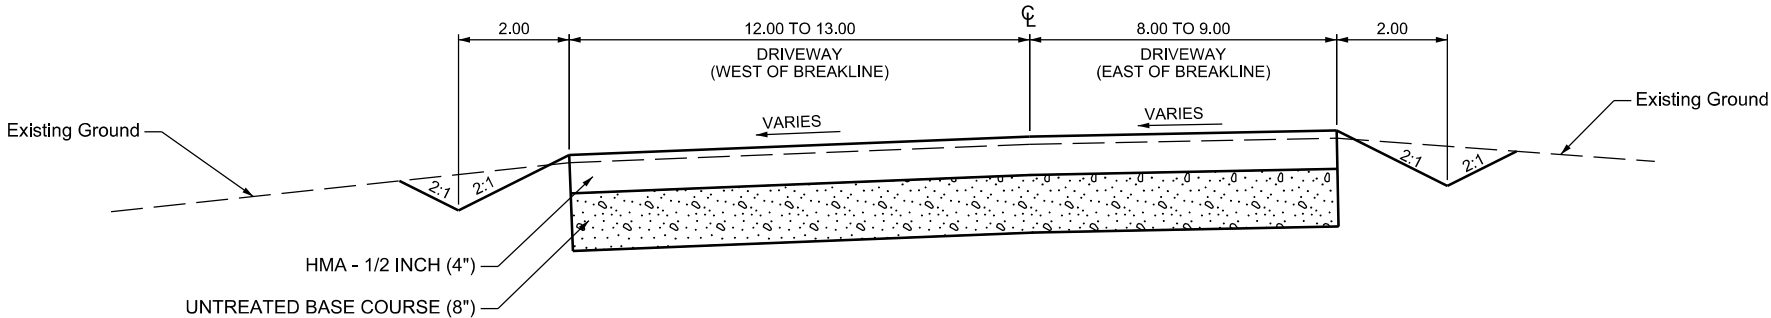


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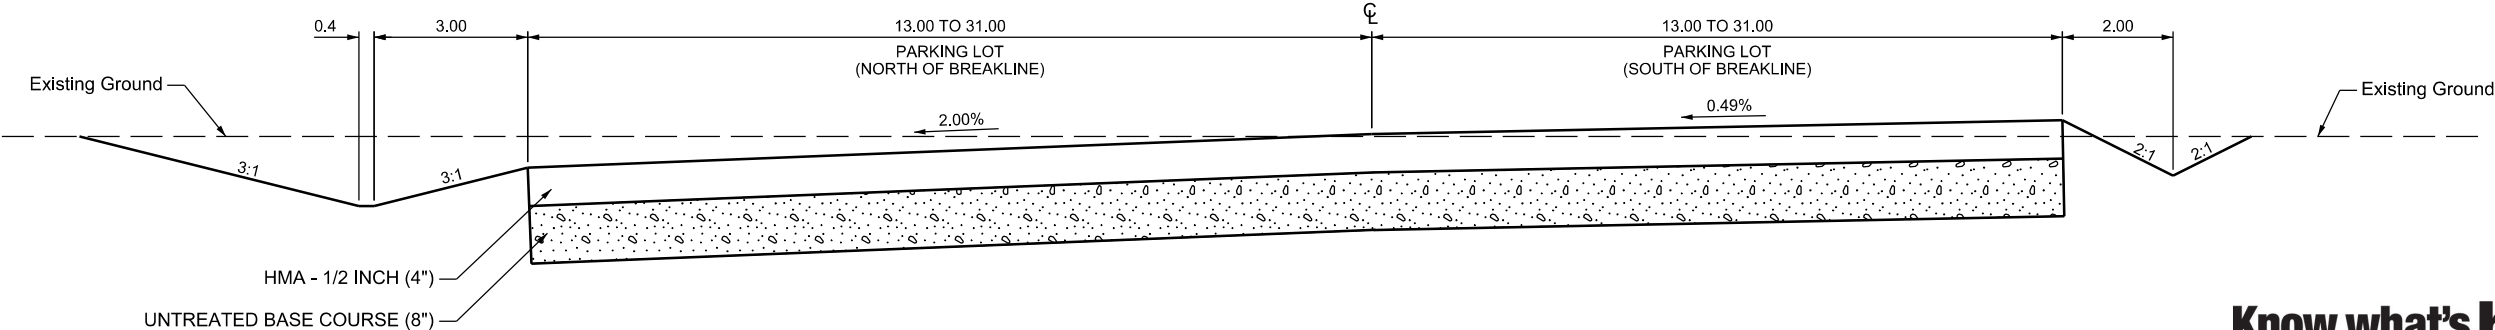
3/14/2023 p:\1\wils\pwbentley.com\115-pa\Documents\8100-TRN\Misc Clients\22-100-307-00 The Perfect Dress Parking Lot Design\drawing files\Typical Section Sheet 01



Existing Section 1
Driveway

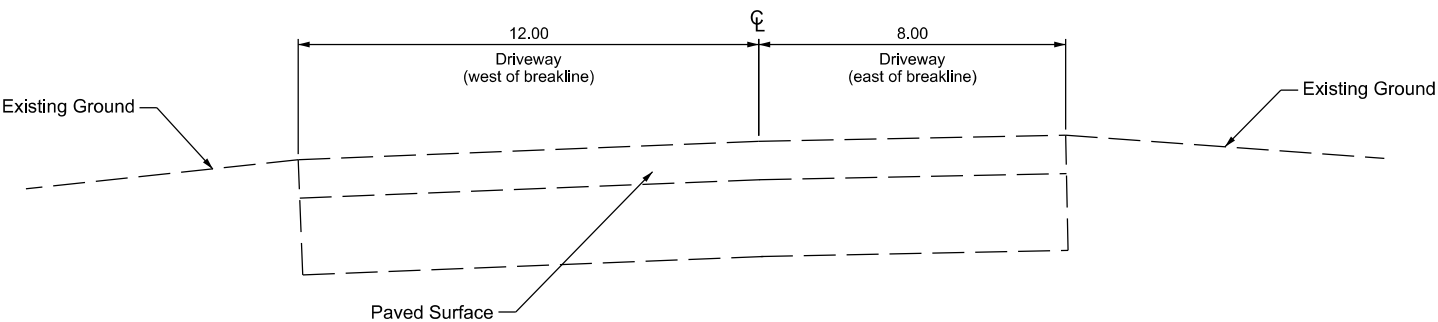

TYPICAL SECTION 1
DRIVEWAY




TYPICAL SECTION 2
PARKING LOT

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THE PERFECT DRESS		THE PERFECT DRESS		DRAWN BY		QC		CHECKED BY		DATE	
PARKING LOT DESIGN		434 MAIN STREET AMERICAN FORK UT		AAD		TWT		03/14/2023			
AMERICAN FORK, UTAH		APPROVED		TWT		TWT		03/14/2023			
TYPICAL SECTION											
PROJECT		PROJECT NUMBER									



CURVE DATA							
CURVE	PC		CC		PT		RADIUS
	NORTHING	EASTING	NORTHING	EASTING	NORTHING	EASTING	
A	308348.0417	554424.1375	308346.5650	554427.6679	308343.0244	554429.1201	5.00
B	308379.0242	554429.2447	308375.4937	554427.7680	308347.0415	554424.2275	5.00
C	308375.1138	554526.2318	308366.1657	554524.8338	308357.9797	554520.7851	30.00
D	308320.2052	554503.0416	308332.1847	554504.9211	308343.0506	554510.3039	40.00
E	308329.8417	554481.8833	308325.1200	554482.9560	308320.2750	554482.8678	20.11
F	308329.8238	554487.0748	308321.3659	554485.2197	308314.1808	554480.3876	23.16

A scale bar labeled "Feet" with markings at 0, 2, and 10. The bar is divided into five equal segments, each 2 units long.

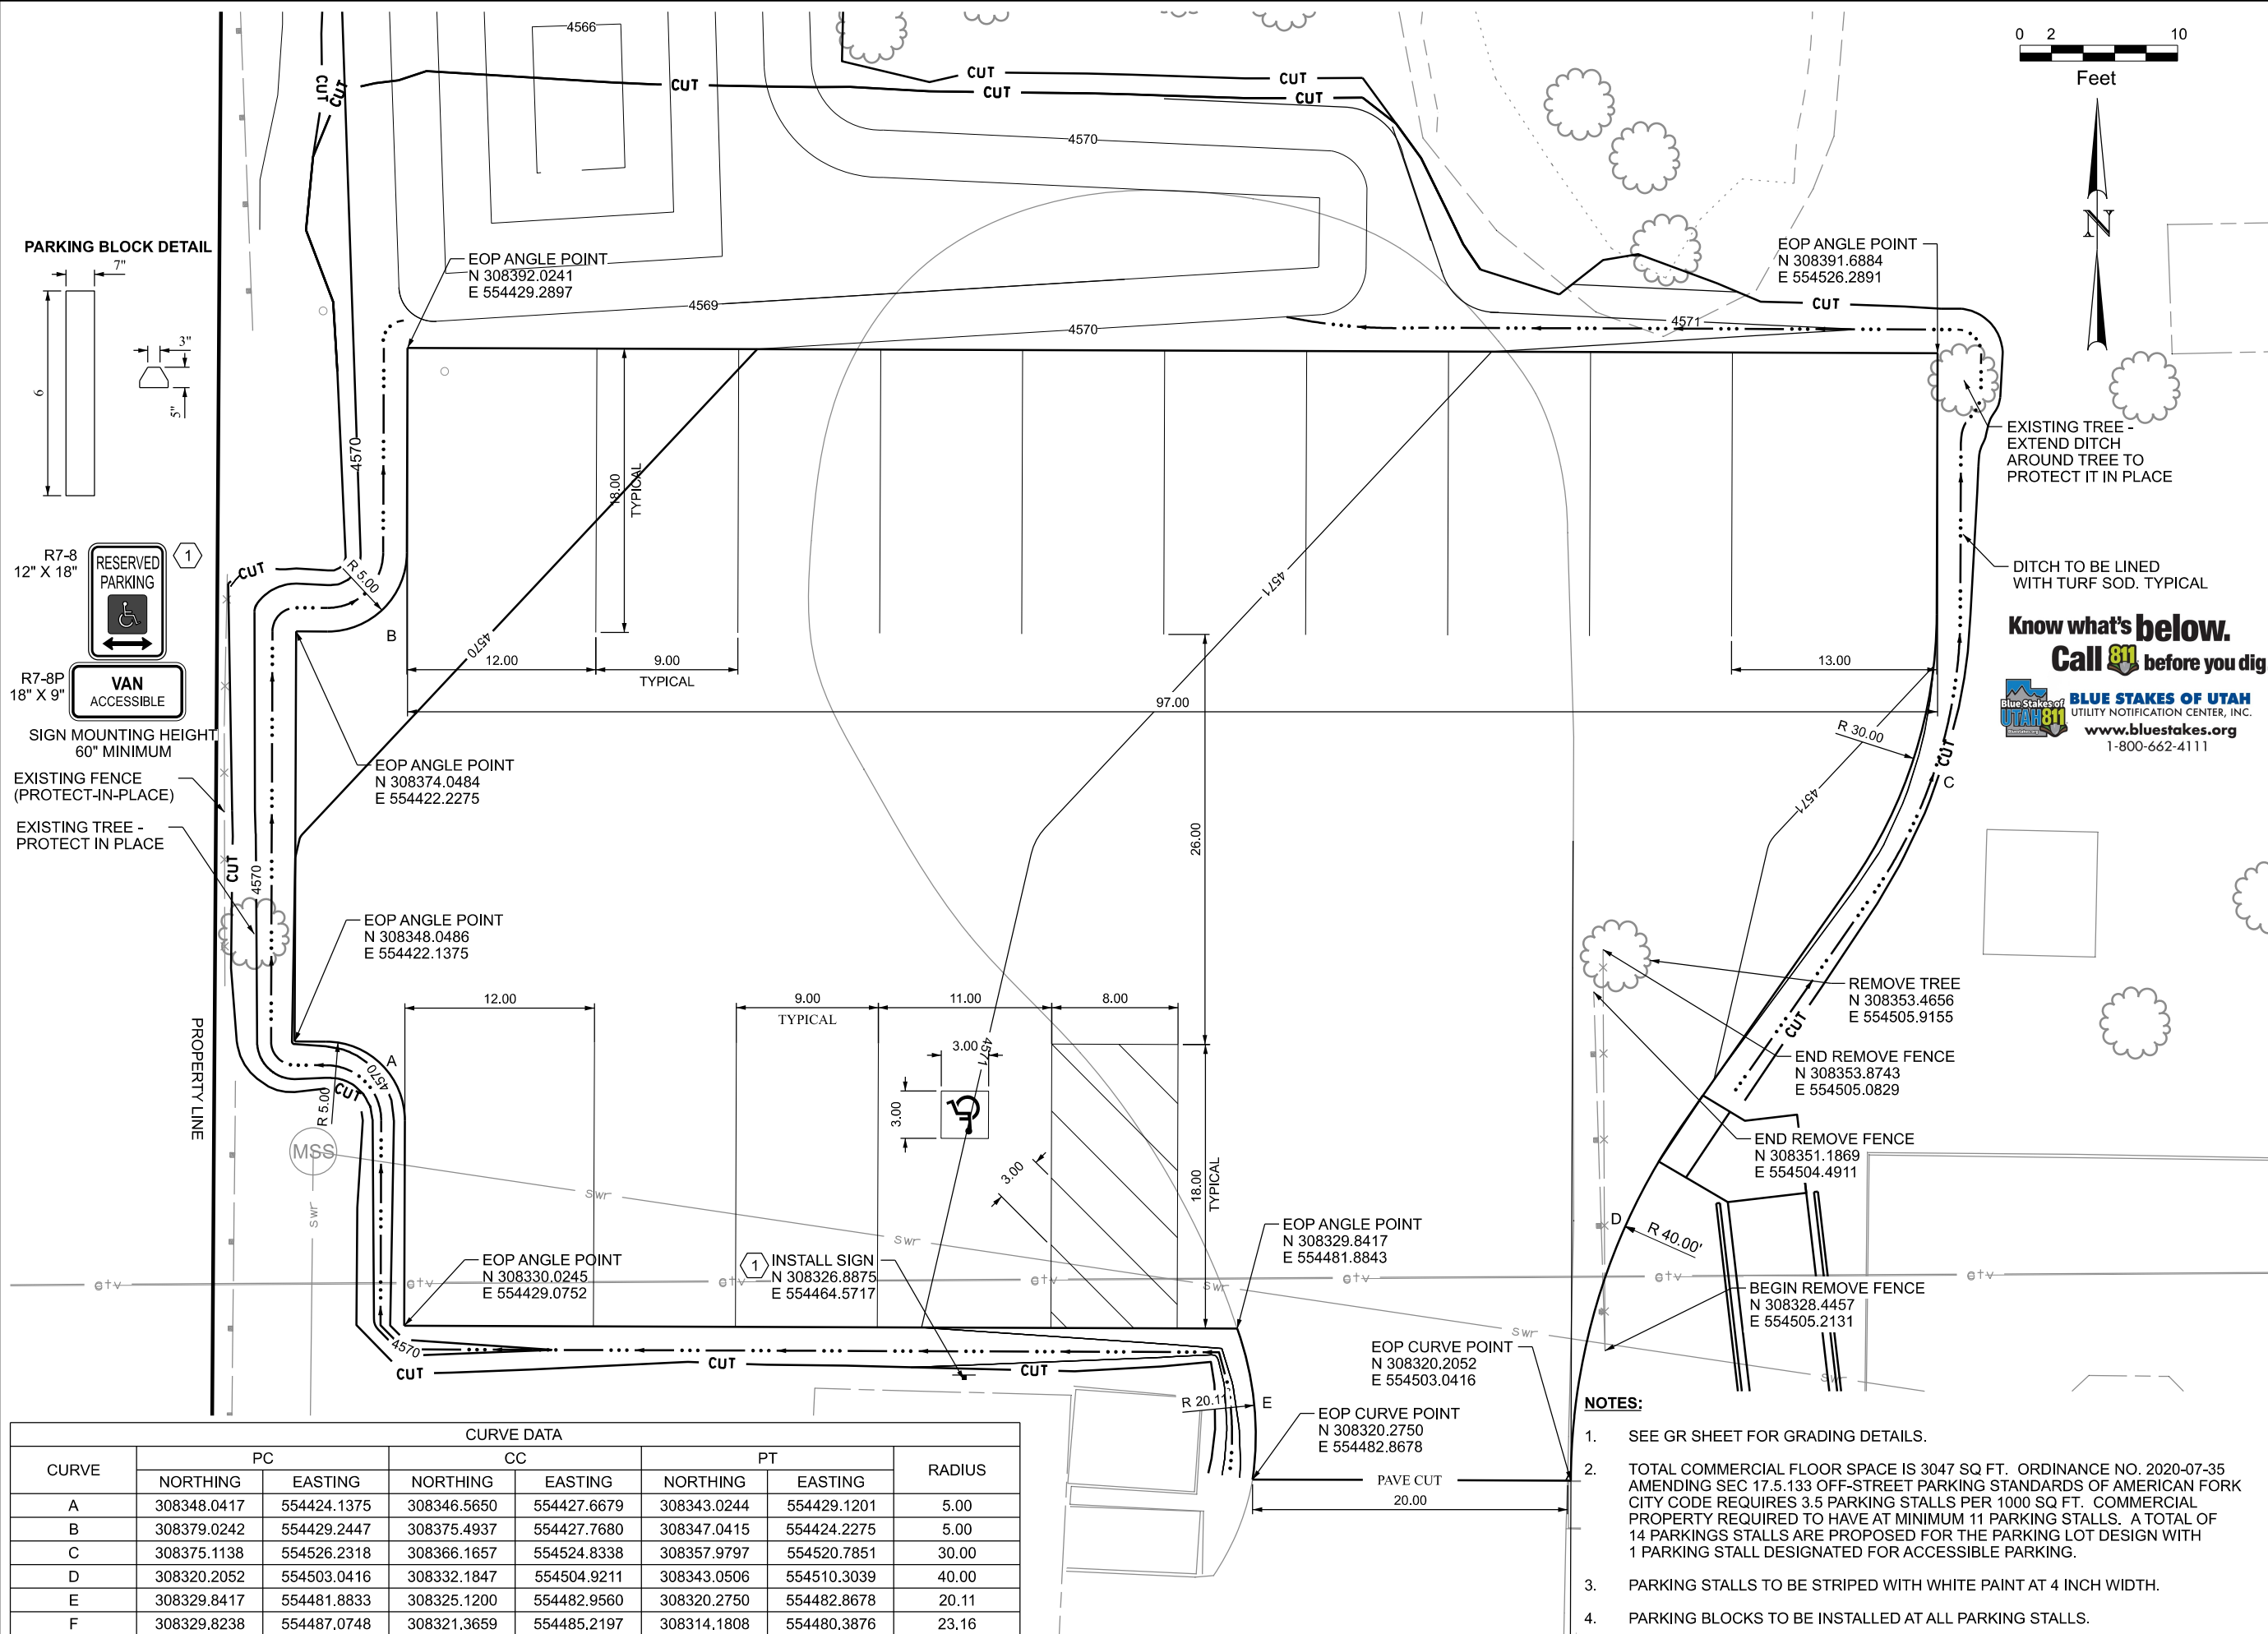— EXISTING TREE -
EXTEND DITCH
AROUND TREE TO
PROTECT IT IN PLACE

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& COMPANY
ENGINEERS & ARCHITECTS

THE PERFECT DRESS
434 MAIN STREET AMERICAN FORK


APPROVED _____

THE PERFECT DRESS
PARKING LOT DESIGN
AMERICAN FORK, UTAH
ROADWAY

SHEET NO. RD-01

NOTES:

3/14/2023 c:\wils\pawbentley\comalls-p\Documents\8100-TRIV\Misc Clients\22-100-307-00 The Perfect Dress Parking Lot Design\drawing files\Roadkey Sheet 02

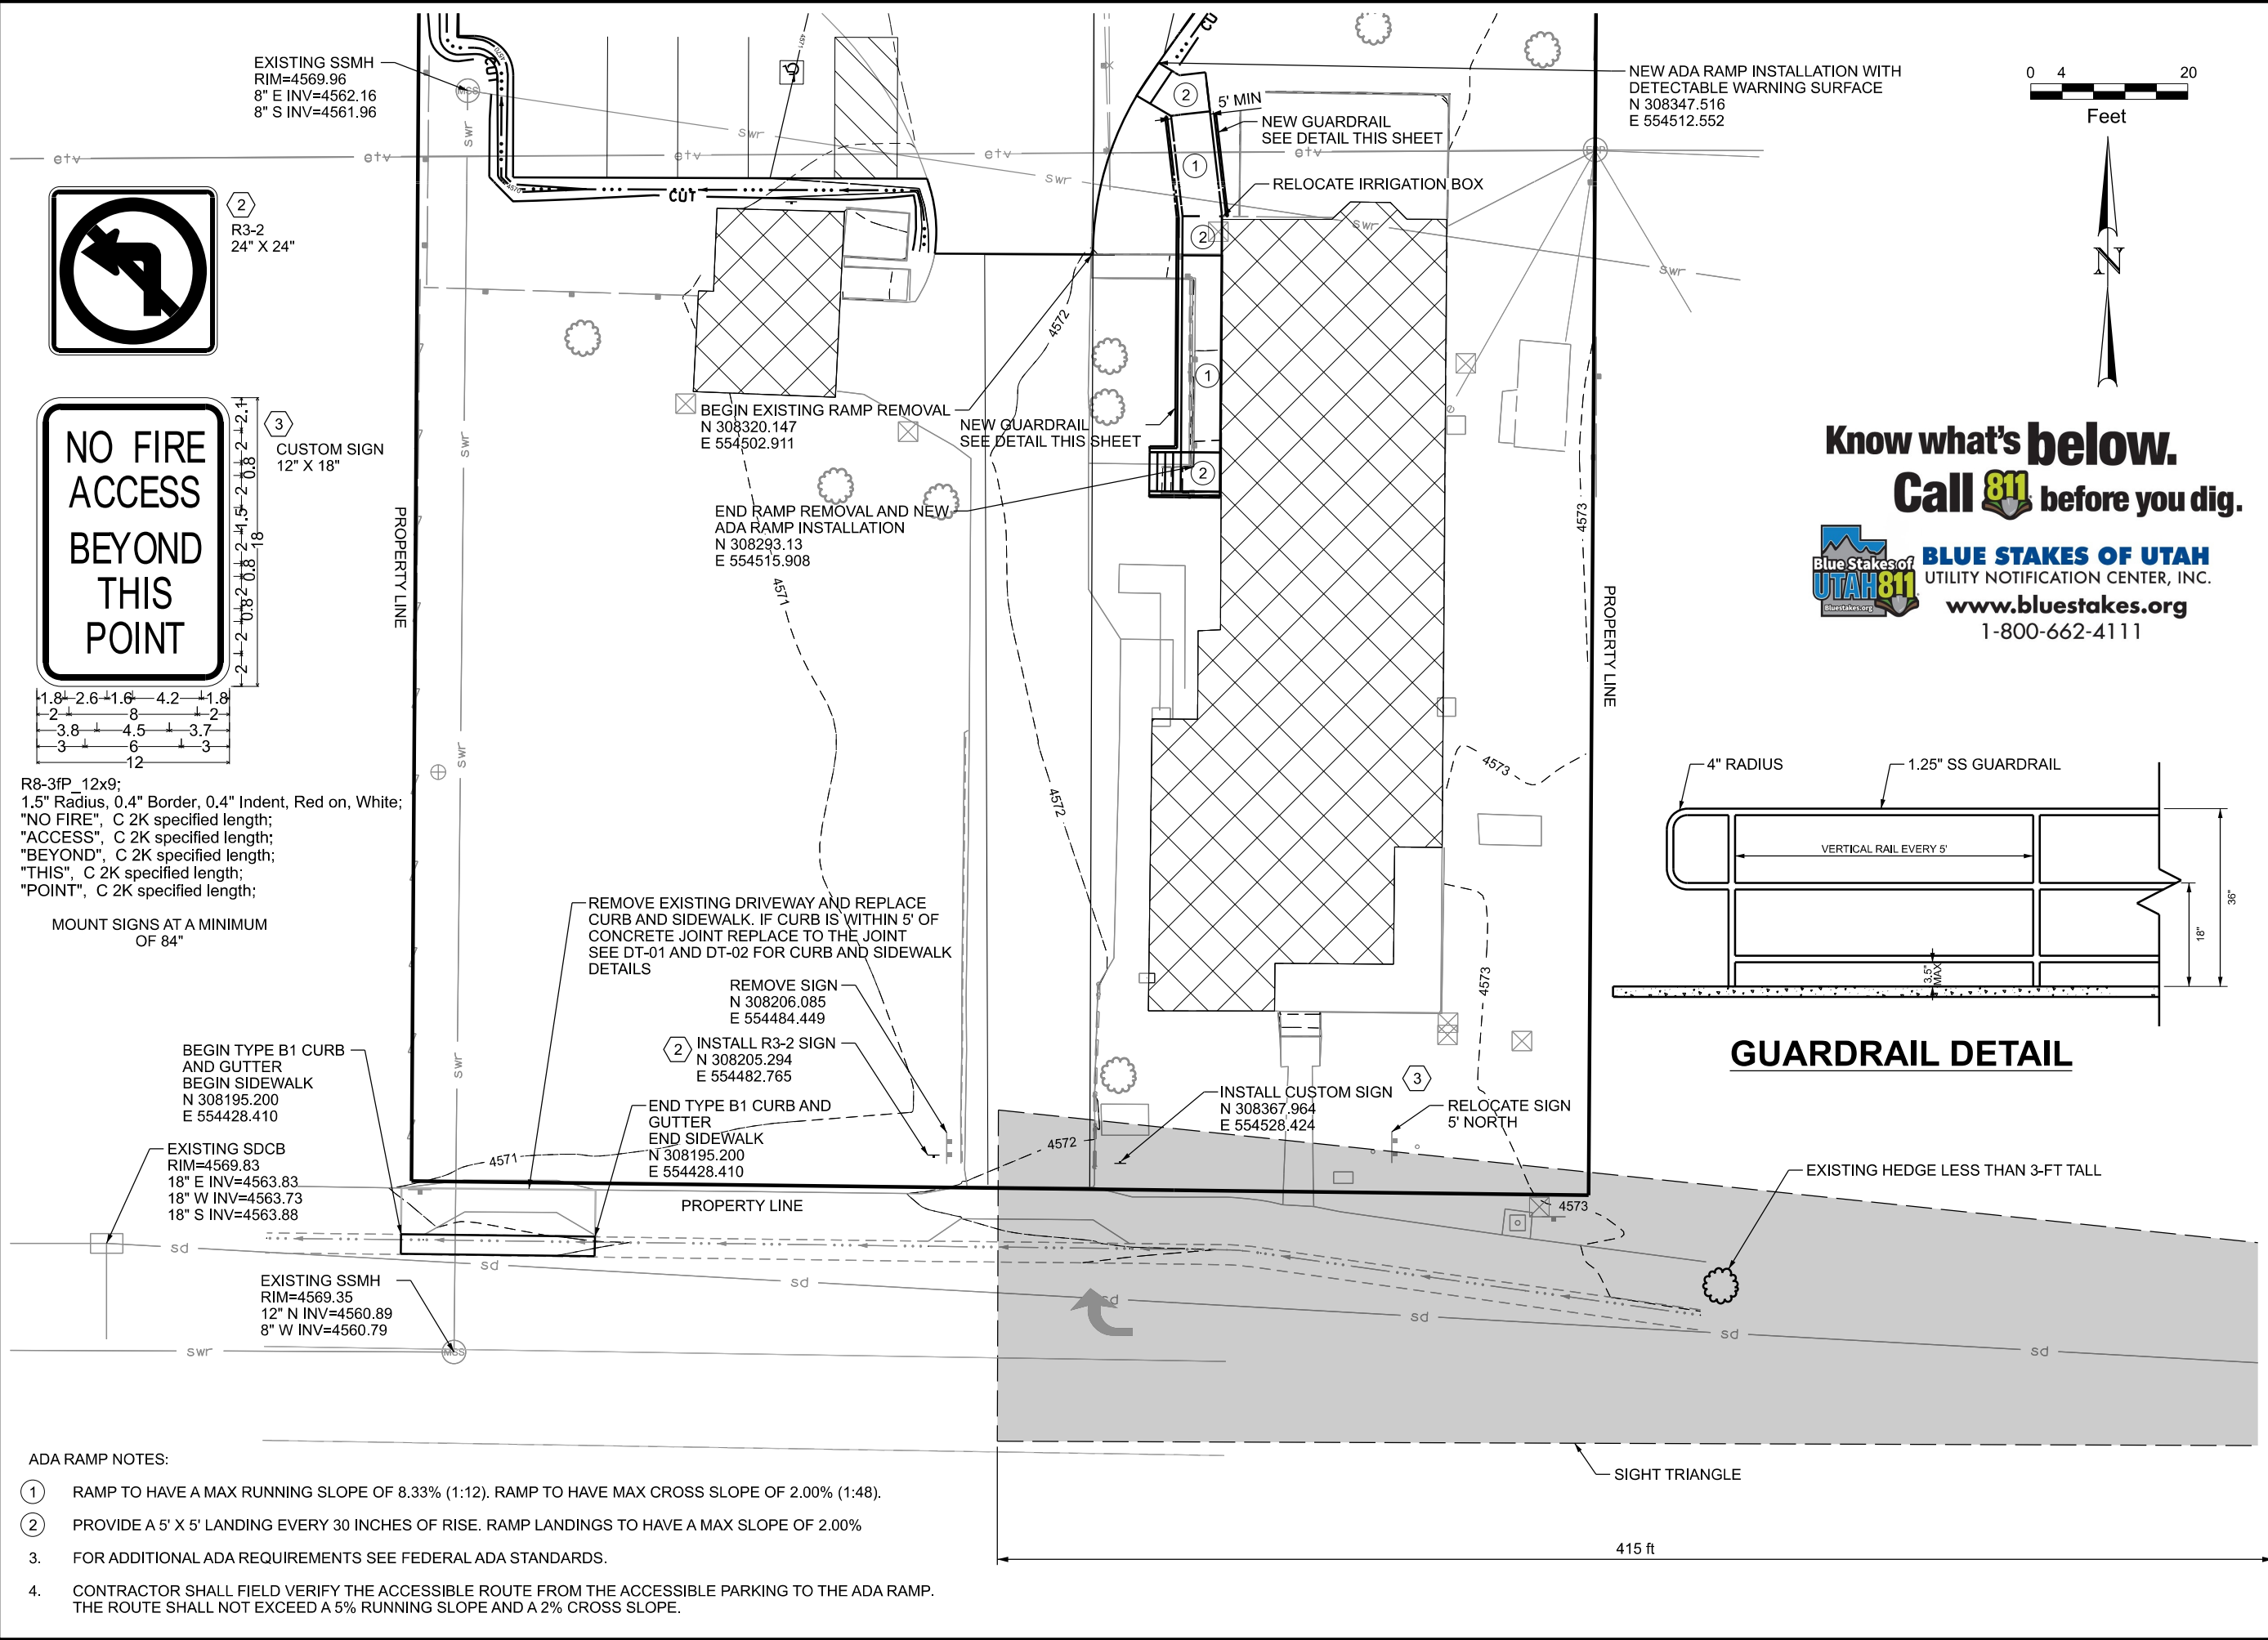

ADA RAMP NOTES:

- 1 RAMP TO HAVE A MAX RUNNING SLOPE OF 8.33% (1:12). RAMP TO HAVE MAX CROSS SLOPE OF 2.00% (1:48).
- 2 PROVIDE A 5' X 5' LANDING EVERY 30 INCHES OF RISE. RAMP LANDINGS TO HAVE A MAX SLOPE OF 2.00%
3. FOR ADDITIONAL ADA REQUIREMENTS SEE FEDERAL ADA STANDARDS.
4. CONTRACTOR SHALL FIELD VERIFY THE ACCESSIBLE ROUTE FROM THE ACCESSIBLE PARKING TO THE ADA RAMP. THE ROUTE SHALL NOT EXCEED A 5% RUNNING SLOPE AND A 2% CROSS SLOPE.

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
**WILSON
& COMPANY**
ENGINEERS & ARCHITECTS

THE PERFECT DRESS 434 MAIN STREET AMERICAN FORK UT		DRAWN BY ADD	TWT
APPROVED <i>Scott W. Shattler</i>		QC 03/14/2023	CHECKED BY DATE
PROJECT THE PERFECT DRESS	PROJECT PARKING LOT DESIGN	PROJECT AMERICAN FORK, UTAH	
ADA RAMP AND SIGN DETAILS			

SHEET NO. RD-02



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SHEET NO.		UT-01	
PROJECT	THE PERFECT DRESS	434 MAIN STREET AMERICAN FORK UT THE PERFECT DRESS 03/14/2023 DATE  APPROVED	
	PARKING LOT DESIGN		
PROJECT NUMBER	AMERICAN FORK, UTAH		
		UTILITY	DRAWN BY QC CHECKED BY TWT ADD


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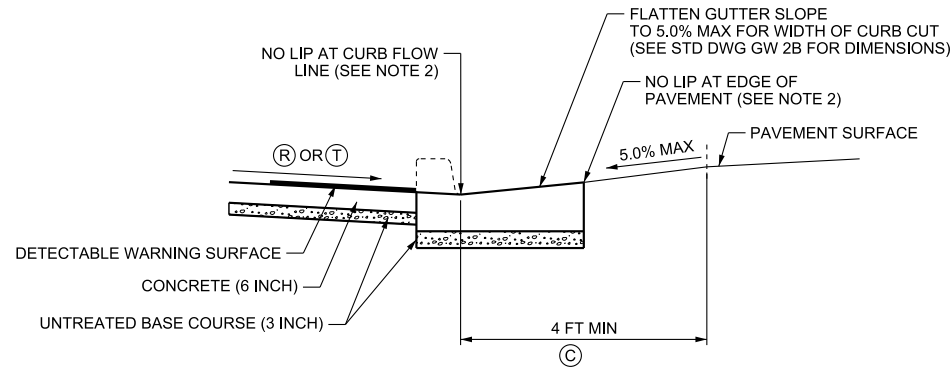


		THE PERFECT DRESS		WILSON & COMPANY ENGINEERS & ARCHITECTS		10813 South River Front Parkway, Suite 475 South Jordan, UT 84095 Phone (801) 307-2845
		434 MAIN STREET AMERICAN FORK UT				
		APPROVED _____		DRAWN BY _____		
		FOR INFORMATION ONLY _____ DATE _____		QC CHECKED BY _____		
				TWT _____		
PROJECT	THE PERFECT DRESS					
	PARKING LOT DESIGN					
PROJECT NUMBER	AMERICAN FORK, UTAH					
	ROADWAY DETAIL					
SHEET NO.		DT-01				


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3/14/2023


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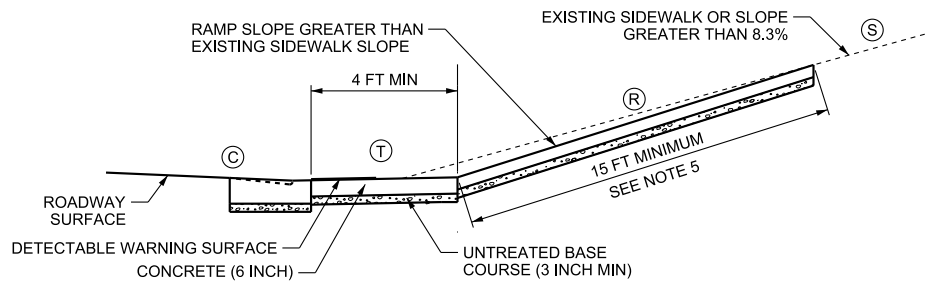
**CLEAR SPACE
DETAIL A**

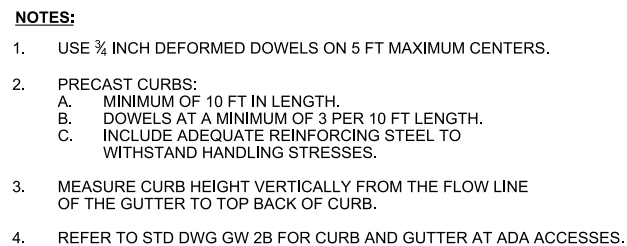


**SIGNING FOR PROHIBITED PEDESTRIAN CROSSING
DETAIL B**

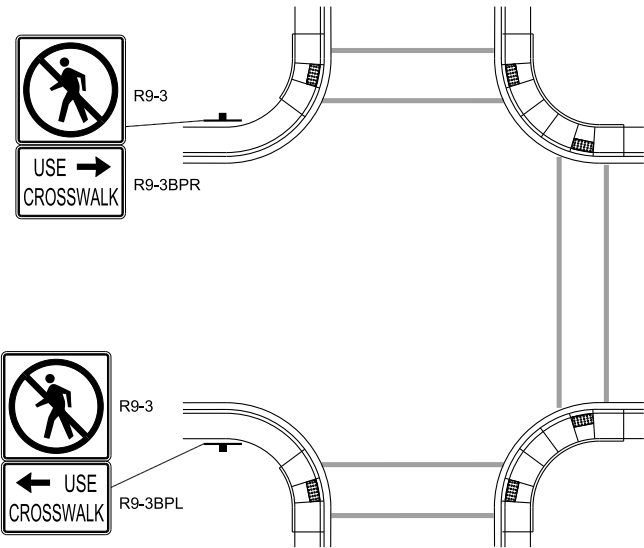


**PASSING SPACE
DETAIL C
SEE NOTE 4**

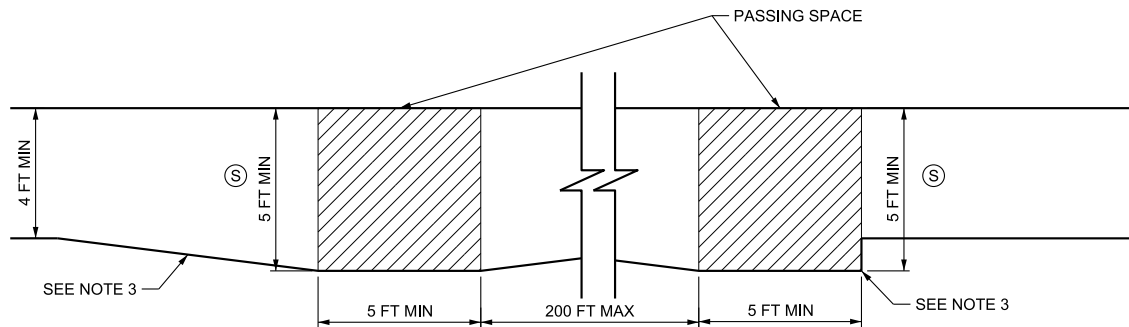

**RAMP SLOPE STEEPENED TO MATCH EXISTING GRADE
RAMP RUNNING SLOPE EXCEPTION
DETAIL D**

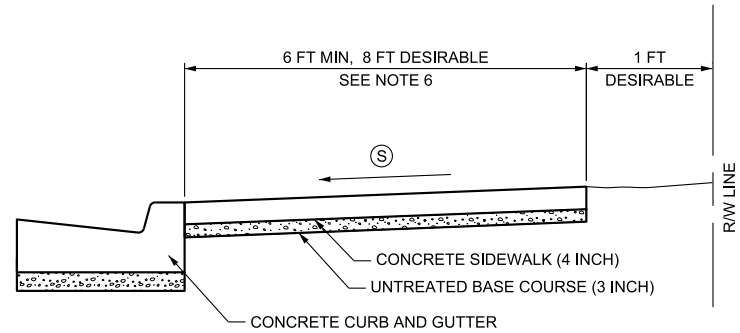

**NO PARKSTRIP
DETAIL E**

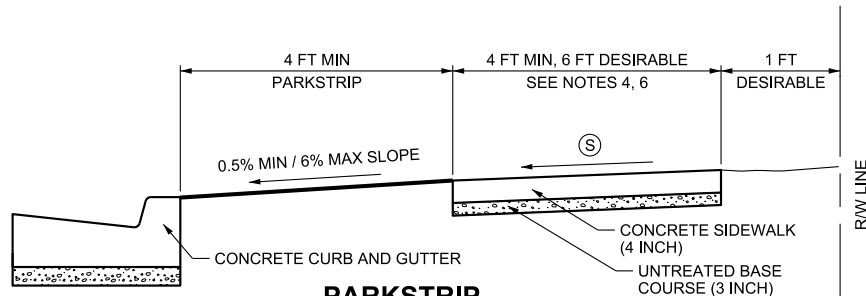

**PARKSTRIP
DETAIL F**

NOTES:

1. REFER TO STD DWG PA 1 FOR DIMENSION TABLE AND GENERAL NOTES.
2. SEE STD DWG PA 1, NOTE 6 FOR VERTICAL DIFFERENCE ALLOWANCES OR TREATMENTS.
3. FLARE AT A RATE EQUAL TO THE PANEL WIDTH TO ALLOW TRANSITIONS ACROSS WHOLE PANELS WHEN A TAPER RATE IS USED TO TRANSITION FROM AND TO A PASSING SPACE. USE A 5:1 FLARE RATE FOR A 5 FT WIDE SIDEWALK FOR EXAMPLE. TAPER RATE MAY BE MODIFIED OR OMITTED WHERE SITE CONDITIONS PROHIBIT USE.
4. SIDEWALK WIDTH IS EXCLUSIVE OF THE WIDTH OF THE CURB. PROVIDE 5 FT X 5 FT PASSING SPACES AT 200 FT MAX. INTERVALS WHERE SIDEWALK WIDTH IS LESS THAN 5 FT (PROWAG R302.3 - R302.4). DRIVEWAYS AND OTHER PAVED AREAS MAY BE USED AS A PASSING SPACE WHERE A MINIMUM 5 FT WIDE AREA MEETING SIDEWALK REQUIREMENTS IS PROVIDED.
5. WHEN THE SIDEWALK OR STREET SLOPE IS GREATER THAN 8.3% AND THE 8.3% MAXIMUM RAMP RUNNING SLOPE CAN NOT BE MET IN 15 FT OF THE ADJACENT TURNING SPACE EDGE, THEN STEEPEN THE RAMP FOR AT LEAST 15 FEET OR TO THE NEXT FURTHER JOINT BEYOND 15 FEET (PROWAG R304.2.2, R304.3.2). THIS WILL RESULT IN THE RAMP RUNNING SLOPE EXCEEDING THE ORIGINAL SIDEWALK OR STREET SLOPE ABOVE 8.3% AND IS ACCEPTABLE. WHERE THE SIDEWALK IS ATTACHED TO THE CURB AND GUTTER, ADJUST THE CURB HEIGHT TO MATCH THE SURFACE ELEVATION OF THE STEEPENED RAMP.
6. THE FOLLOWING MINIMUM WIDTHS ARE REQUIRED FROM BACK OF CURB TO BACK OF SIDEWALK AT DRIVEWAY LOCATIONS TO MEET GRADING REQUIREMENTS:
 - TYPE B1 CURB AND GUTTER: 7.67 FT
 - TYPE B2 CURB AND GUTTER: 9.75 FT
 - TYPE M2 CURB AND GUTTER: 5.08 FT

REVISIONS				REMARKS
NO.	DATE	BY	APPR.	
3	2/17/22	TRE		UPDATED RAMP RUNNING SLOPE DETAIL NOTE 5, AND CLEAR SPACE DETAIL
2	2/28/19	CSW		NAMING FOR UTBC AND CONCRETE REVISED. REFERENCE IN DT1 UPDATED
1	2/22/18	CSW		NEW DRAWING
		NCL		

UTAH DEPARTMENT OF TRANSPORTATION		DATE
STANDARD DRAWINGS FOR ROAD AND BRIDGE CONSTRUCTION		
SALT LAKE CITY, UTAH		
RECOMMENDED FOR APPROVAL		
CHAIRMAN STANDARDS COMMITTEE		DATE
APPROVED		
2023 Standard Drawing		
DEPUTY DIRECTOR		DATE

PEDESTRIAN ACCESS DETAILS		STANDARD DRAWING TITLE
STD. DWG. NO.		
PA 3		

PROJECT

THE PERFECT DRESS

PROJECT NUMBER

434 MAIN STREET AMERICAN FORK UT

PROJECT NUMBER

AMERICAN FORK, UTAH

PROJECT NUMBER

ROADWAY DETAIL

DRAWN BY

ADD

QC

CHECKED BY

DATE

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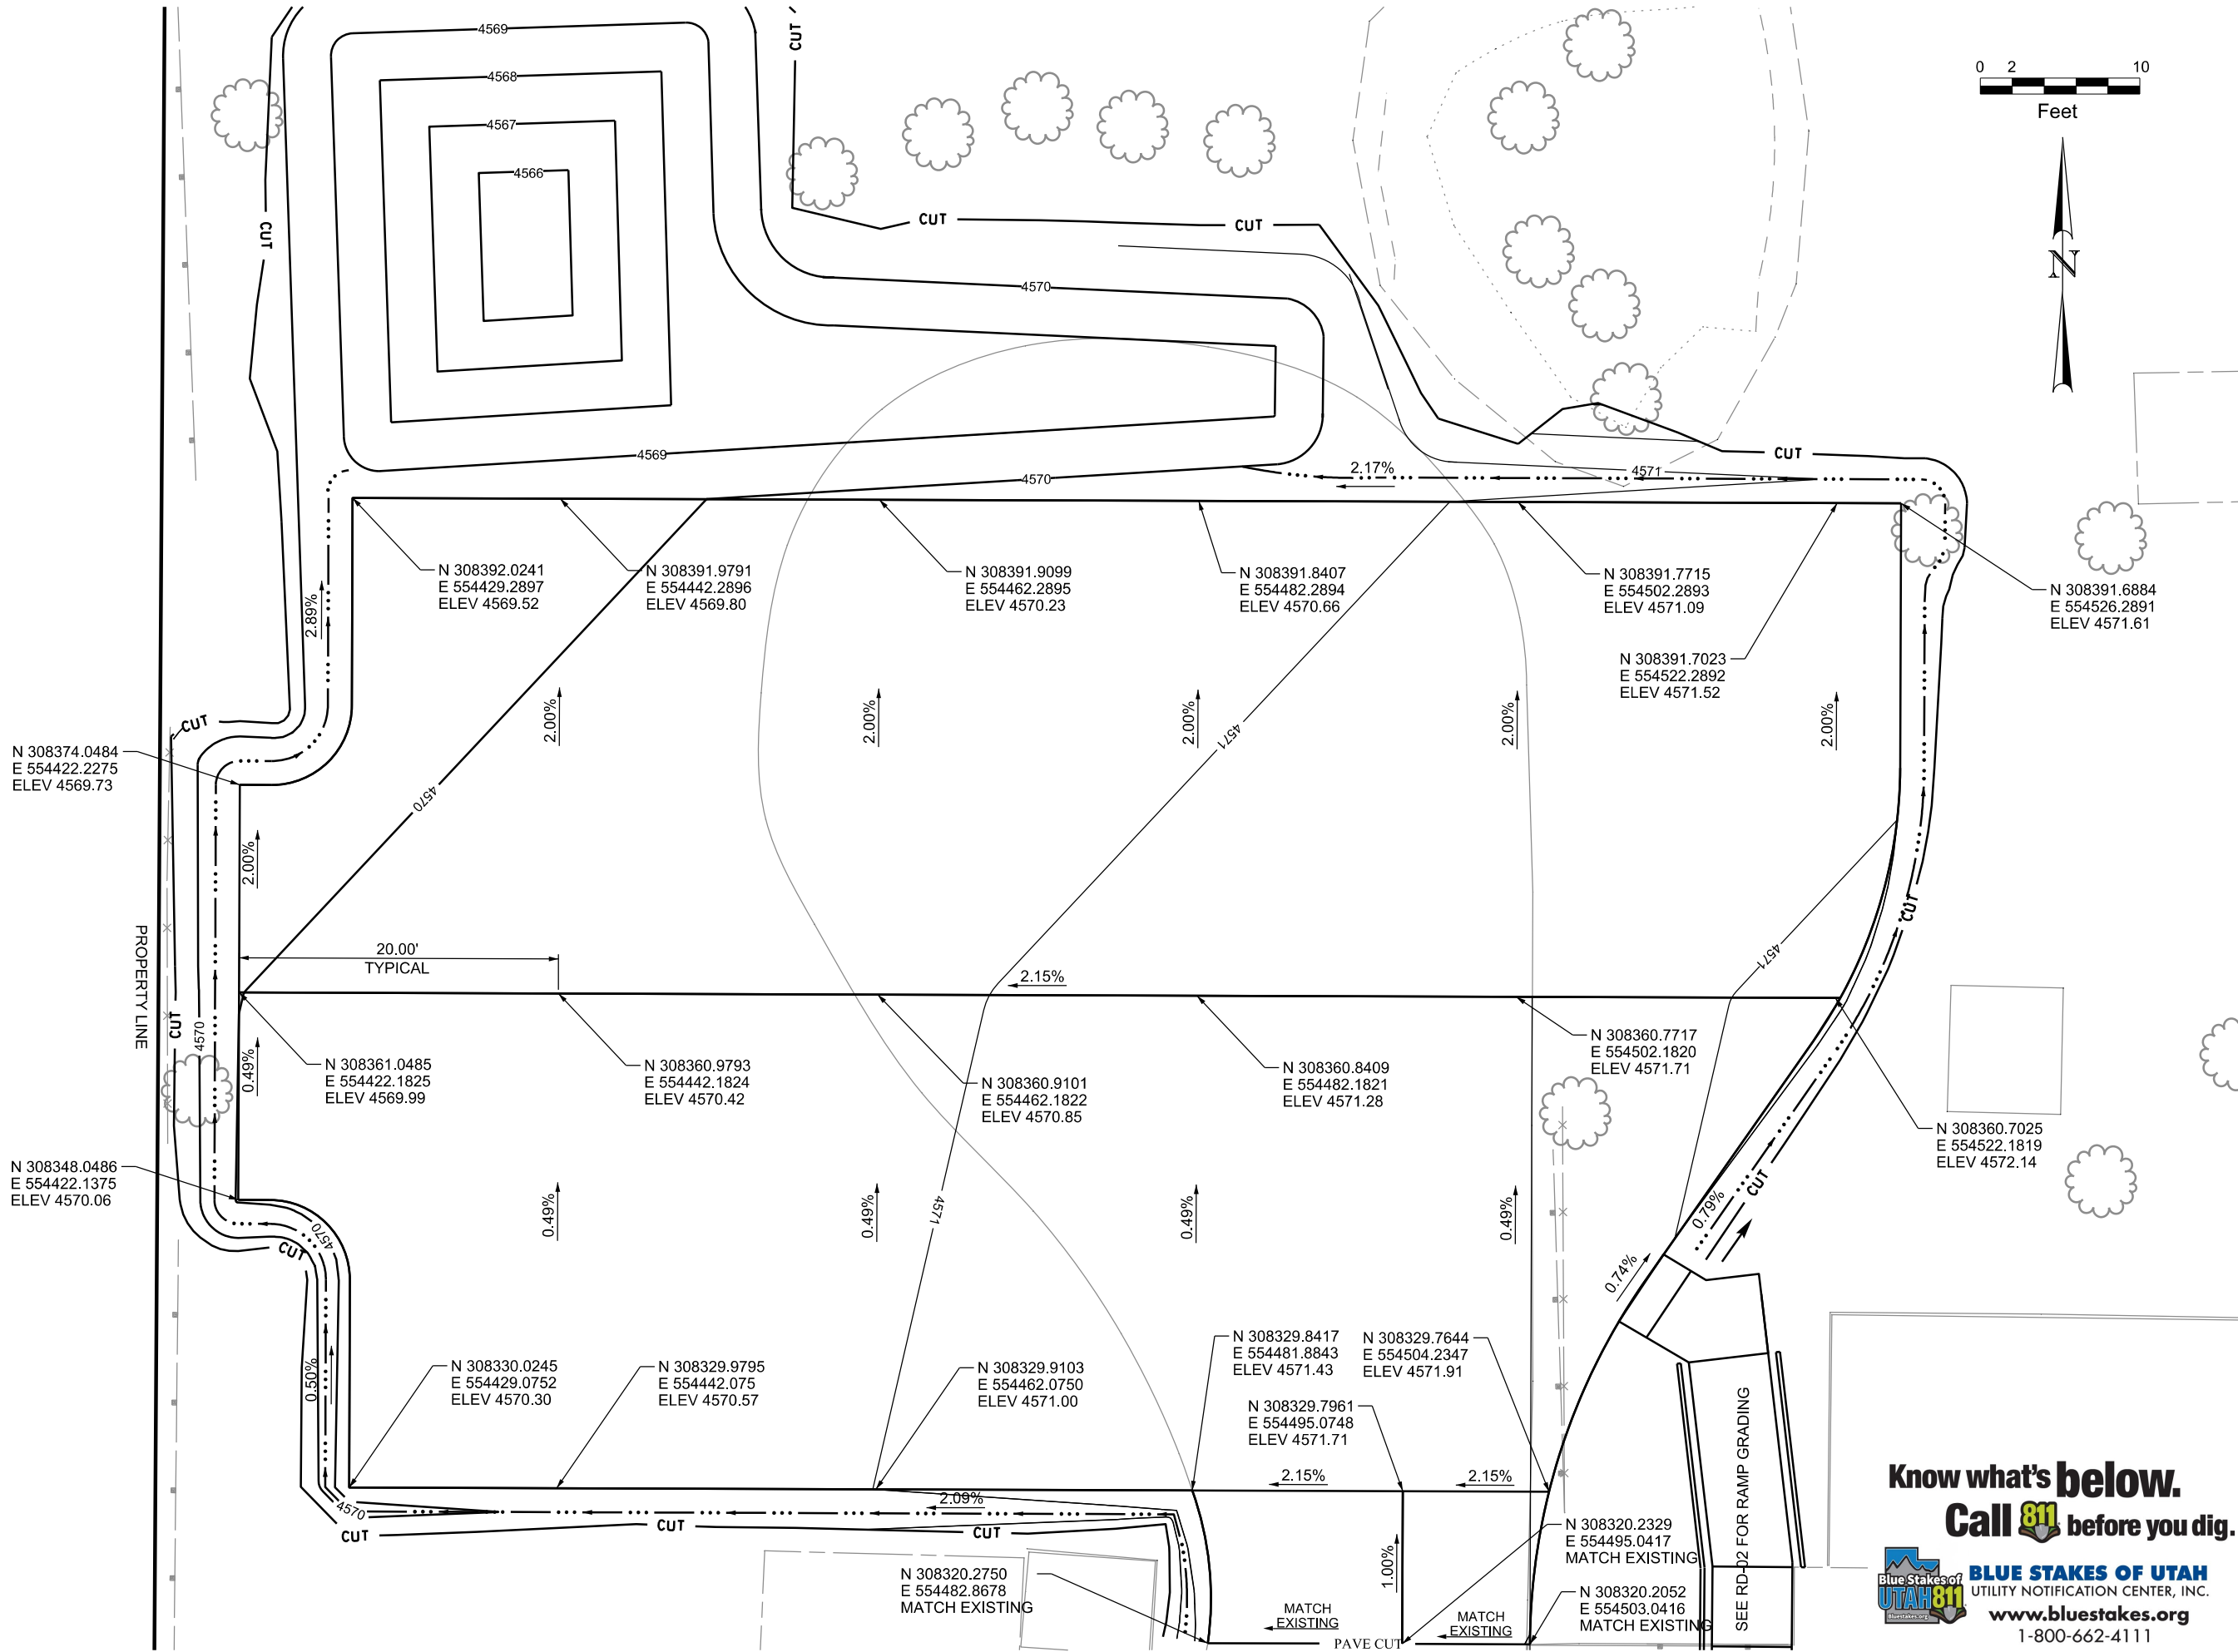
ENGINEERS & ARCHITECTS

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3/14/2023

DT-02

3/14/2023 c:\wils\pwbentley\com\hills-pa\Documents\8100-TRN\Misc Clients\22-100-307-00 The Perfect Dress Parking Lot Design\drawing files\Grading Sheet 01



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PROJECT		PARKING LOT DESIGN		PROJECT NUMBER		AAD		TWT	
THE PERFECT DRESS		434 MAIN STREET AMERICAN FORK UT		APPROVED		DATE		03/14/2023	
AMERICAN FORK, UTAH		GRADING		SIGNATURE		DATE		03/14/2023	

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ENGINEERS & ARCHITECTS

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SHEET NO.		GR-02	
PROJECT	THE PERFECT DRESS PARKING LOT DESIGN		
PROJECT NUMBER	AMERICAN FORK, UTAH GRADING		
		APPROVED	DRAWN BY
			QC
			CHECKED BY
			TWT
		DATE	
		03/14/2023	
		ABC	
		TWT	

**AMERICAN FORK CITY
PLANNING COMMISSION STAFF REPORT**

MEETING DATE: March 22nd, 2023

AGENDA TOPIC:

Review and action on an application for an accessory structure in excess of 1,000 square feet, located in the area of 33 East 100 North in the Residential (R4-7500) Zone.

BACKGROUND INFORMATION		
Location:		33 East 100 North
Project Type:		Accessory Structure Site Plan
Applicants:		Adam Anderson
Existing Land Use:		Residential High Density
Proposed Land Use:		N/A
Surrounding Land Use:	North	Residential High Density
	South	Institutional Lands, Schools, and Public Facilities
	East	Residential High Density; General Commercial
	West	Residential High Density; General Commercial
Existing Zoning:		R4-7500
Proposed Zoning:		N/A
Surrounding Zoning:	North	R4-7500
	South	CC-1
	East	CC-1
	West	R4-7500; CC-1

BACKGROUND:

The applicant is applying for site plan approval for the development of an accessory structure in the R4-7500 Zone, located at 33 E 100 N. The proposal consists of 1 parcel for an addition to an existing accessory structure. The entire development parcel consists of 0.30 acres. The accessory structure exceeds the 1000 square foot requirement to be brought to the Planning Commission and Planning Commission will be the approval body for this structure.

Sec 17.5.105 Area Of Accessory Buildings

Accessory buildings shall not be larger than an area two times the size of the footprint (foundation) of the primary structure; or cover more than twenty-five percent of the total rear yard area of a lot, whichever is less. All accessory buildings shall be of a character which is consistent and compatible with the bulk, height, style and construction materials of existing dwellings in the immediate vicinity. There shall be no signage on any portion of the accessory building and the area surrounding the accessory building shall be landscaped. An accessory building containing a building footprint of one thousand square feet or larger shall require approval of the planning commission, subject to the following findings: (1) the accessory building will be incidental to the primary use of the parcel, (2) the applicant has provided adequate assurance that neither the accessory building nor any portion thereof will be used or converted for use as living or sleeping quarters (see Section 17.5.106) or for the conduct of a business (except when located in a commercial zone permitting such activity), and (3) the bulk, height, style and construction material of the accessory structure is compatible with dwellings in the immediate vicinity and will not result in an undue negative impact upon adjacent properties.

PROJECT MAP:



PROJECT CONDITIONS OF APPROVAL:

1. All Fire Marshall comments will need to be addressed before permits are approved.
2. Provide grading for the project site. Ensure all storm water is retained on site.

FINDINGS OF FACT:

- The Accessory Structure addition meets the requirements of Section 17.5.105 of American Fork City Code.
- Applicant will need to sign a document stating that the accessory building will be incidental to the primary use of the parcel, the accessory building nor any portion thereof will not be used or converted for use as living or sleeping quarters, and the accessory building will not be used for the conduct of a business.

STANDARD CONDITIONS OF APPROVAL:

APPLICANT is responsible and shall submit/post/obtain all necessary documentation and evidence to comply with these Standard Conditions of Approval prior to any platting, permitting, or any other form of authorization by the City including plat recording or other property conveyance to the City and prior to scheduling a pre-construction meeting. All recording shall take place at the Utah County Recorder's Office.

1. **Title Report:** Submit an updated Title Report not older than 30 days or other type of appropriate verification that shows all dedications to the City are free and clear of encumbrances, taxes, or other assessments.
2. **Property Taxes and Liens:** Submit evidence that all the property taxes, for the current and/or previous years, liens, and agricultural land use roll over fees have been paid in full.
3. **Water Rights:** Submit evidence that all the required water rights have been conveyed to American Fork City.
4. **Performance Guarantee:** Post a performance guarantee for all required public and essential common improvements.
5. **Easements and Agreements:** Submit/record a long-term Storm Water Pollution Prevention Maintenance Agreement signed and dated by the property owner and any required easement documentation.
6. **Land Disturbance Permit:** Obtain a Land Disturbance Permit.
7. **Compliance with the Plan Review Comments:** All plans and documents shall comply with all the Technical Review Committee comments and the City Engineer's final review.
8. **Commercial Structure:** Record an Owner Acknowledgment and Utility Liability Indemnification if the proposed building is a multi-unit commercial structure served by a single utility service.
9. **Sensitive Lands:** Record all applicable documents required for compliance with the City's Sensitive Lands Ordinance.
10. **Utility Notification Form:** Submit a Subdivision Utility Notification Form.
11. **Professional Verification:** Submit final stamped construction documentation by all appropriate professionals.

12. **Fees:** Payment of all development, inspection, recording, streetlight, and other project related fees.
13. **Mylar:** Submit a Mylar. All plats will receive final verification of all formats, notes, conveyances, and other items contained on the plat by City staff (recorder, legal, engineer, GIS, planning).

STAFF RECOMMENDATION:

The Accessory Structure meets the requirements of Section 17.5.105 and staff recommends APPROVING the application WITH CONDITIONS.

POTENTIAL MOTIONS – Accessory Structure Site Plan

APPROVAL


I move that we approve the Accessory Structure in excess of 1,000 square feet, located in the area of 33 East 100 North in the Residential (R4-7500) Zone, subject to any conditions found in the Staff Report.

DENIAL

I move that we deny the Accessory Structure in excess of 1,000 square feet, located in the area of 33 East 100 North in the Residential (R4-7500) Zone

TABLE

I move that we table action on the Accessory Structure in excess of 1,000 square feet, located in the area of 33 East 100 North in the Residential (R4-7500) Zone, and instruct the developer/staff to _____.

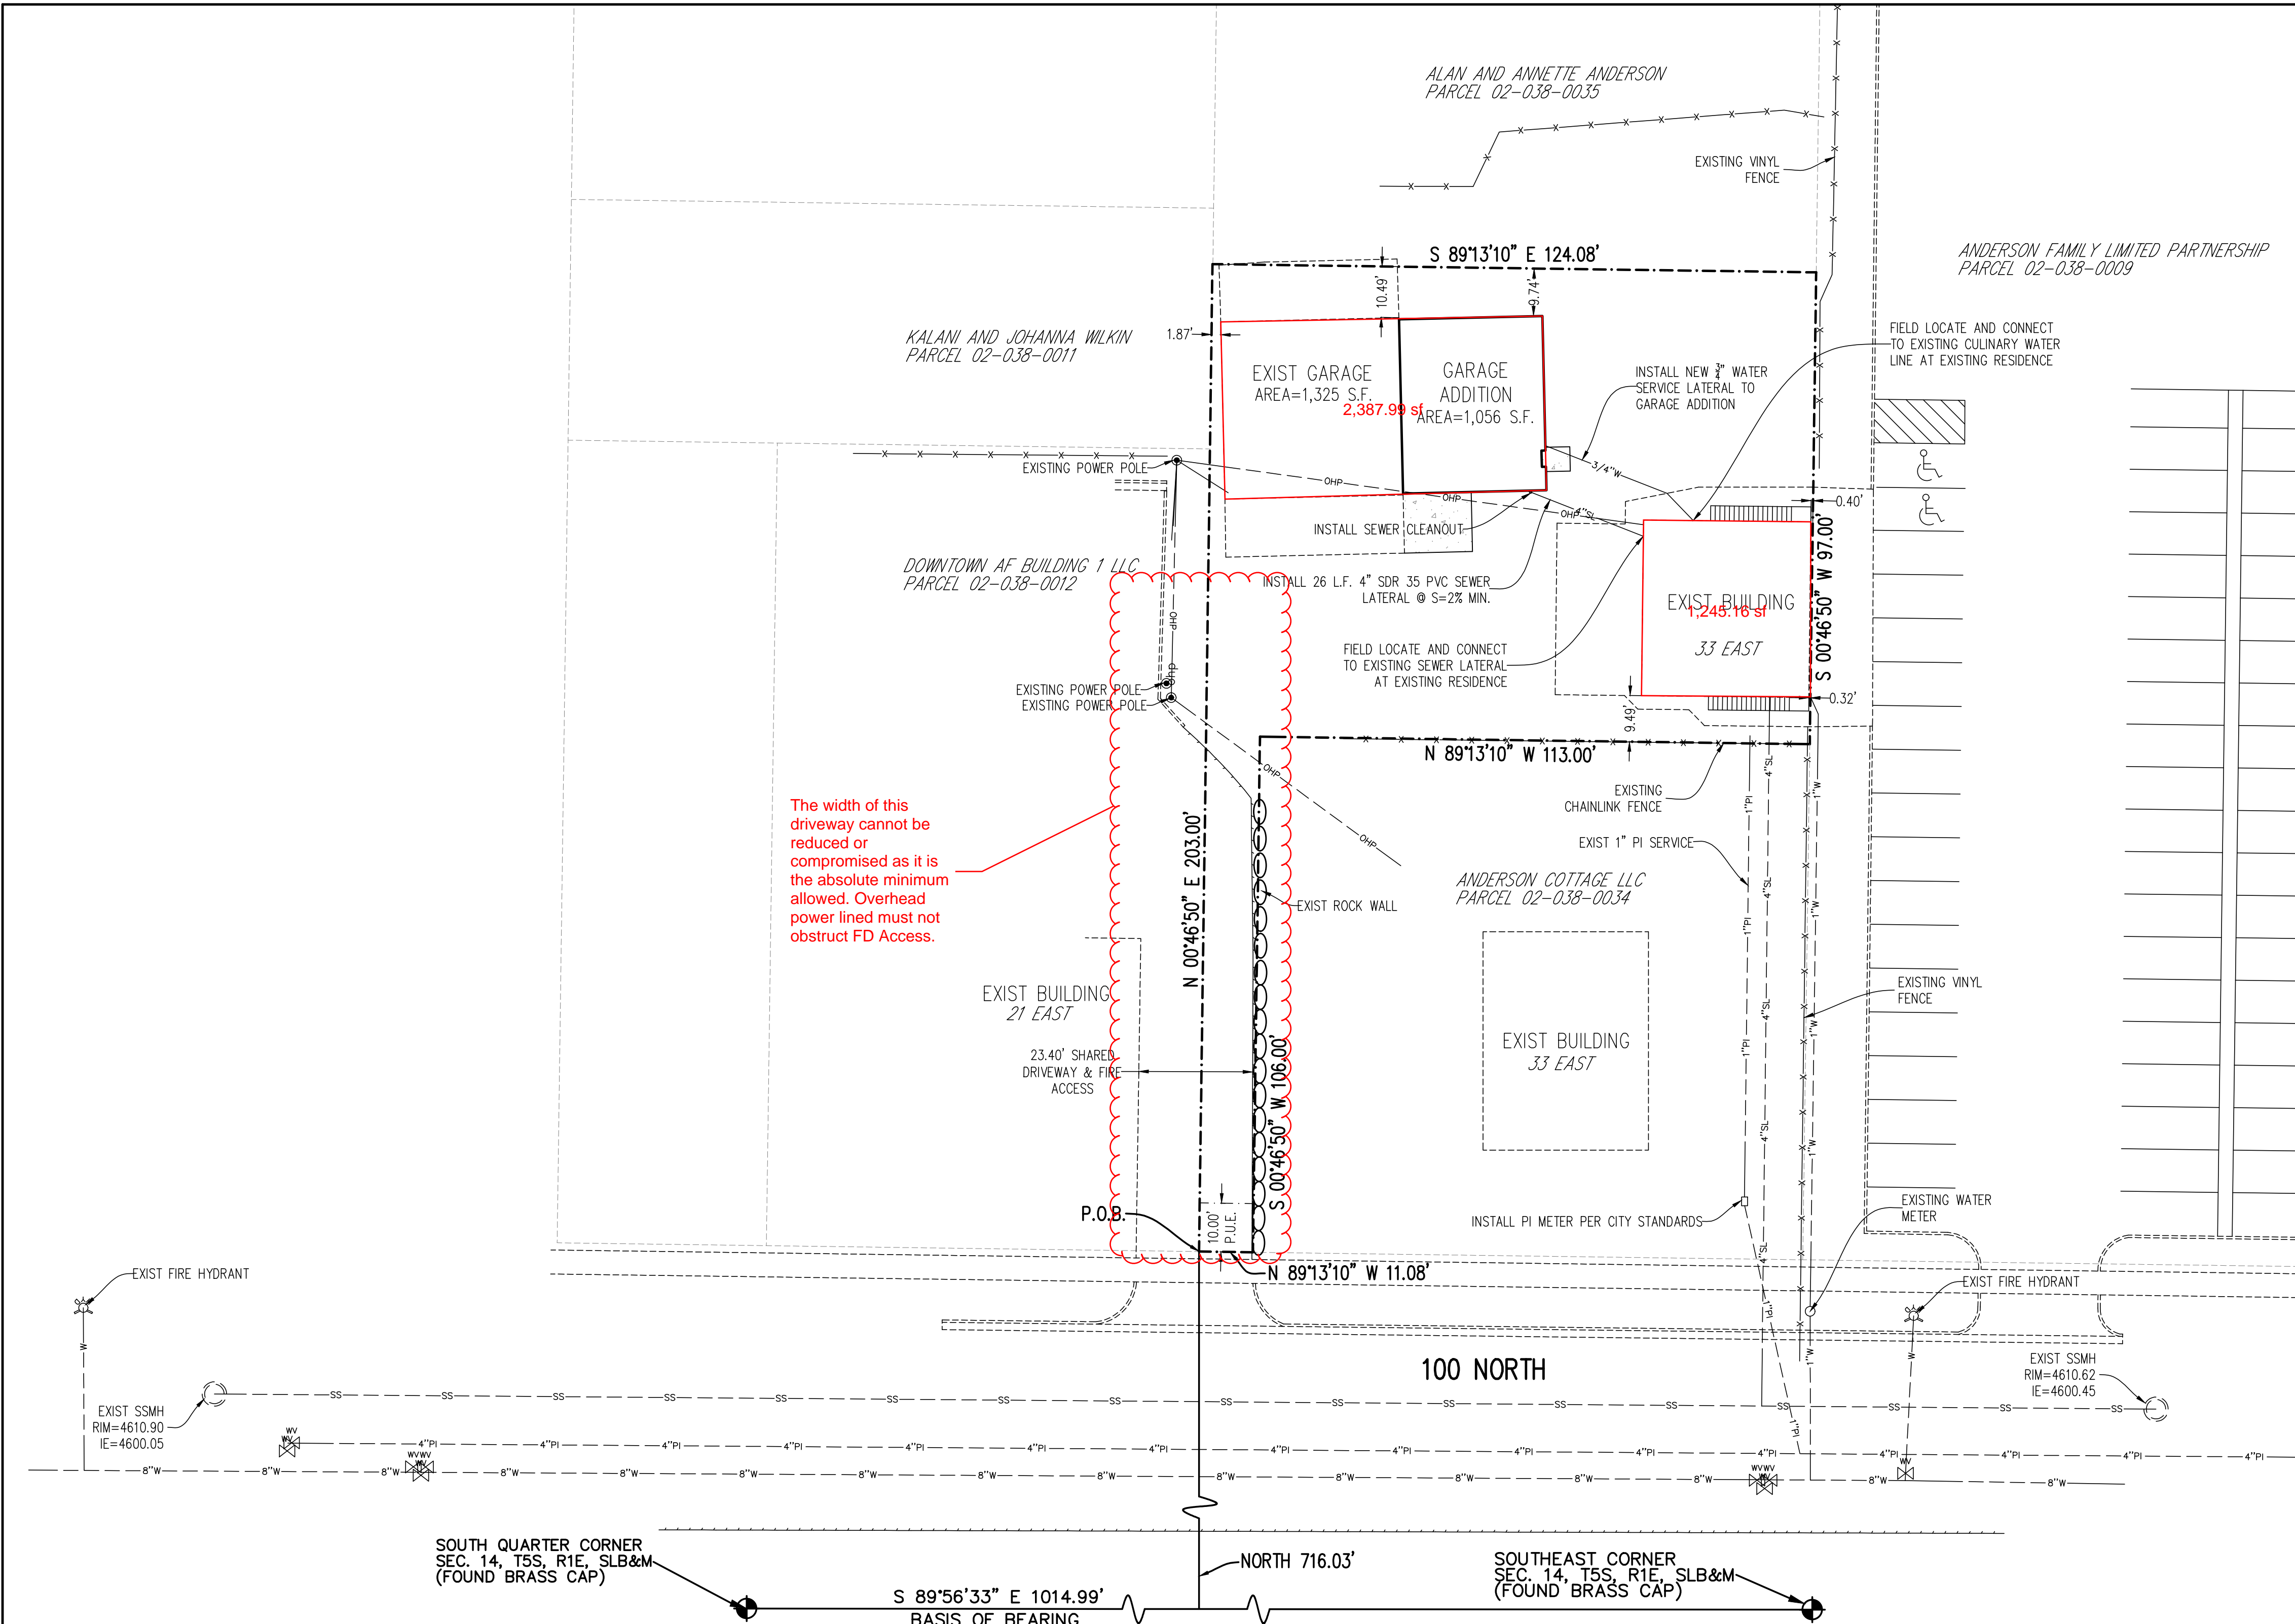

SEWER NOTES:

1. ALL SEWER MAINS AND LATERALS MUST BE INSPECTED AND APPROVED BY THE CITY OF AMERICAN FORK PUBLIC WORKS DEPARTMENT INSPECTOR BEFORE TRENCH BACKFILLING IS COMPLETED.
2. SEWER LATERALS ARE TO BE INSTALLED AT A MINIMUM SLOPE OF 2%.
3. NEW SERVICE LATERALS SHALL BE PVC PLASTIC PIPE CONFORMING TO ASTM D3034 SDR35.
4. ALL LATERAL CONNECTIONS SHALL "INSERT-A-TEE" OR WYE AT TEN O'CLOCK OR TWO O'CLOCK POSITIONING TO CENTER OF MAIN LINE AND SHALL BE ENCASED IN CONCRETE AFTER INSPECTION IS MADE.
5. THERE SHALL BE A MINIMUM 3 FEET OF COVER OVER ALL SEWER LATERAL LINES AND 3.5 FEET MINIMUM COVER AT PROPERTY LINE.
6. THERE SHALL BE A MAXIMUM DISTANCE OF 5 FEET FROM THE FOUNDATION WALL TO THE FIRST EXTERIOR CLEANOUT WITH A MAXIMUM DISTANCE BETWEEN CLEANOUTS OF 75 FEET.
7. THERE SHALL A BE CLEANOUT AT ANY 90° BEND OR ANY COMBINATION OF BENDS IN EXCESS OF 90°.
8. CLEANOUT STANDPIPE CAN BE CAST IRON OR IRON OR PVC WITH CAST IRON CAP OR BRASS CAP.
9. ALL CLEANOUTS SHALL REMAIN VISIBLE AND ACCESSIBLE.
10. ALL SEWER CONSTRUCTION MUST CONFORM TO AF CITY STANDARD DRAWINGS.

WATER NOTES:


1. ALL WATER MAINS, TRANSMISSION AND DISTRIBUTION LINES, SHALL BE CONSTRUCTED USING DUCTILE IRON IN ACCORDANCE WITH AWWA C151 AND ANSI A-21.51
2. DUCTILE IRON PIPE SHALL BE CLASS 50 FOR SLIP-ON OR MECHANICAL JOINT PIPING (CLASS 51 FOR 6 INCH SIZE AND UNDER) AND CLASS 53 FOR FLANGED JOINT PIPING UNLESS OTHERWISE REQUIRED BY THE CITY ENGINEER.
3. ALL WATER CONSTRUCTION TO CONFORM TO AF CITY STANDARD DRAWINGS.
4. WATER LINE MIN. COVER IS 48" TO TOP OF PIPE.
5. WATER SERVICE MATERIAL TO BE POLY PIPE.

GENERAL UTILITY NOTES:

1. THERE ARE NO EXISTING LAND DRAINAGE SYSTEMS, WETLANDS, OR DRAINAGE AREAS TRIBUTARY TO THIS SITE.
2. NO UTILITY LINE EXTENSIONS REQUIRED FROM ADJACENT PROPERTY OWNERS.
3. ALL CONSTRUCTION SHALL CONFORM TO AMERICAN FORK CITY STANDARDS AND SPECIFICATIONS, LATEST EDITION.
4. ALL ROOF DRAINS WILL BE CONVEYED TO THE APPROPRIATE UNDERGROUND FACILITY WHERE POSSIBLE, NOT CONVEYED ACROSS PARKING OR SIDEWALK. ROOF DRAINS SHOULD DISCHARGE AT LEAST 10 FEET FROM FOUNDATIONS OR BACKFILL LIMITS, WHICHEVER IS GREATER. CONNECT ALL ROOF DRAINS TO STORM DRAIN PIPING SHOWN WHERE POSSIBLE.

FIRE HYDANT NOTE

1. CONSTRUCTION TYPE = VB
2. TOTAL SQUARE FOOTAGE = 2,381 S.F.
3. REQUIRED FIRE FLOW = 1,500 GPM
4. HYDRANTS REQUIRED FOR 1,500 GPM = 1, THERE ARE EXISTING HYDRANTS ON 100 NORTH TO SATISFY THIS REQUIREMENT.

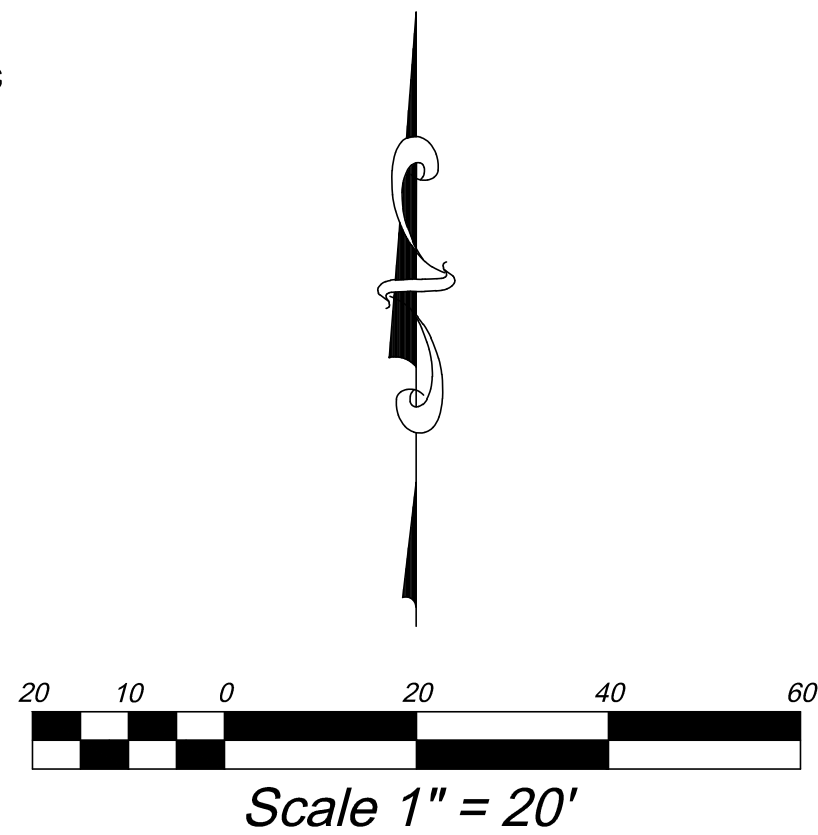

UTILITY LEGEND

- FIRE HYDRANT
- 6"PI PRESSURE IRRIG.
- 8"W CULINARY WATER
- 8"SS SEWER PIPE PVC SDR-35
- 15"SD STORM DRAIN PIPE
- EDGE OF ASPHALT
- FENCE
- OHP OVERHEAD POWER LINE
- G GAS LINE

NOTES TO CONTRACTOR

1. CONTRACTOR TO FIELD VERIFY ALL EXISTING CURB & GUTTER, STORM DRAIN, & SEWER ELEVATIONS OR INVERTS PRIOR TO CONSTRUCTION AND NOTIFY ENGINEER WHEN ELEVATIONS OR INVERTS DO NOT MATCH PLANS.
2. THE LOCATION OF EXISTING UNDERGROUND UTILITIES IS SHOWN IN APPROXIMATE LOCATIONS. THE CONTRACTOR SHALL DETERMINE THE EXACT LOCATION OF ALL EXISTING UTILITIES BEFORE COMMENCING WORK. HE AGREES TO BE FULLY RESPONSIBLE FOR ANY AND ALL DAMAGES WHICH MIGHT BE OCCASIONED BY HIS FAILURE TO EXACTLY LOCATE AND PRESERVE AND ALL UNDERGROUND UTILITIES, WHETHER OR NOT SUCH FACILITIES ARE SHOWN ON THESE PLANS.


BOUNDARY DESCRIPTION

BEGINNING AT A POINT LOCATED NORTH 89°13'10" WEST 522.59 FEET ALONG THE SOUTHERLY BLOCK LINE OF BLOCK 25, PLAT "A" AMERICAN FORK CITY SURVEY OF BUILDING LOTS, SAID POINT ALSO BEING LOCATED SOUTH 89°56'33" EAST ALONG THE SECTION LINE 1014.99 FEET AND NORTH 716.03 FEET FROM THE SOUTH QUARTER CORNER OF SECTION 14, TOWNSHIP 5 SOUTH, RANGE 1 EAST, SALT LAKE BASE AND MERIDIAN; THENCE NORTH 00°46'50" EAST 203.00 FEET; THENCE SOUTH 89°13'10" EAST 124.08 FEET; THENCE SOUTH 00°46'50" WEST 97.00 FEET; THENCE NORTH 89°13'10" WEST 113.00 FEET; THENCE SOUTH 00°46'50" WEST 106.00 FEET; THENCE NORTH 89°13'10" WEST 11.08 FEET TO THE POINT OF BEGINNING.

AREA = 13,194 SQ. FT. OR 0.3029 ACRES



SHEET INDEX

- C1 SITE & UTILITY PLAN
- C2 GRADING & EROSION CONTROL PLAN

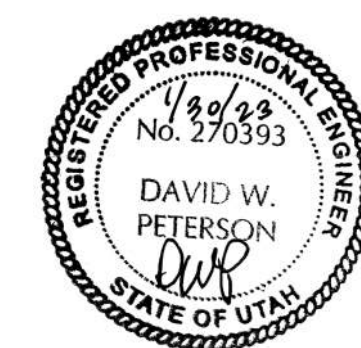

SURVEYOR:
LEVEL OF FOCUS, INC
1334 East 1150 South
Spanish Fork, Utah 84660
(801) 319-5441

BENCH MARK	REVISIONS			Developer: ADAM ANDERSON 95 EAST 200 NORTH, AMERICAN FORK, UT 801-763-8813	ANDERSON GARAGE ADDITION			
SOUTH QUARTER CORNER, SECTION 14, TOWNSHIP 5 SOUTH, RANGE 1 EAST, SALT LAKE BASE AND MERIDIAN ELEVATION = 4594.27 (NGVD 29 DATUM) NAVD 88 IS 3.6' HIGHER THAN NGVD 29	Rev.	Date	Description		AMERICAN FORK 33 EAST 100 NORTH		UTAH	
				<div>EXCE ENGINEERING</div> <div>David W. Peterson, P.E., License #270393 12 West 100 North, Suite 201C, American Fork, UT 84003 P: (801) 756-4504; david@excecivil.com</div>	Drawn by: D.W.P.	SITE & UTILITY PLAN	Scale: 1"=20'	
					Designed by: D.W.P.		Date: 01/30/23	
					Checked by:		C1	
					D.W.P.			

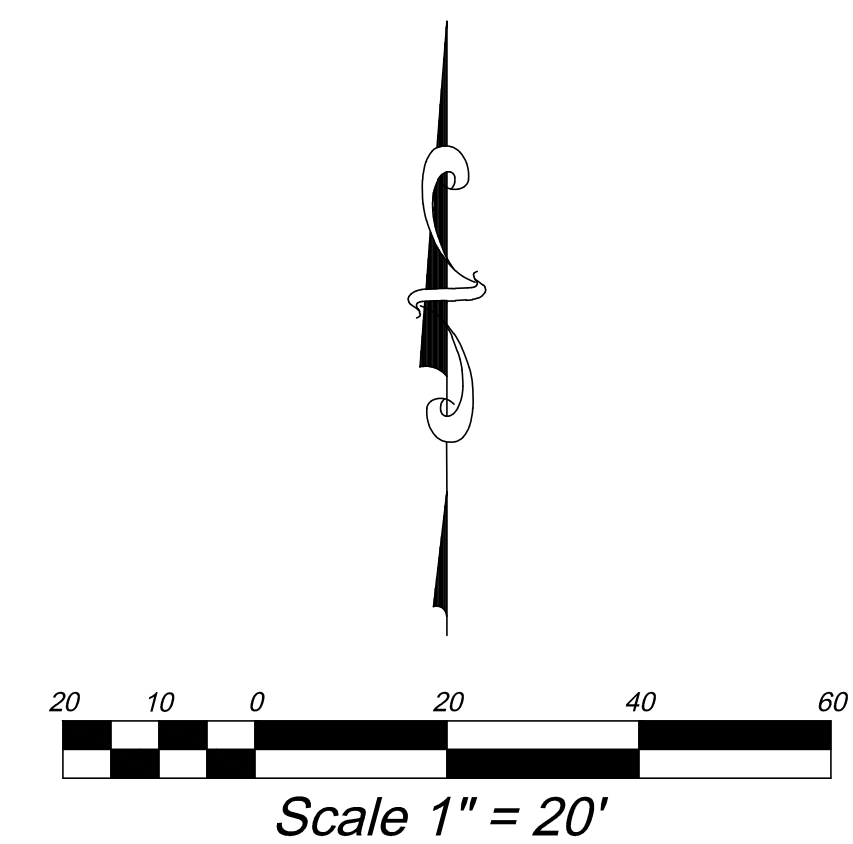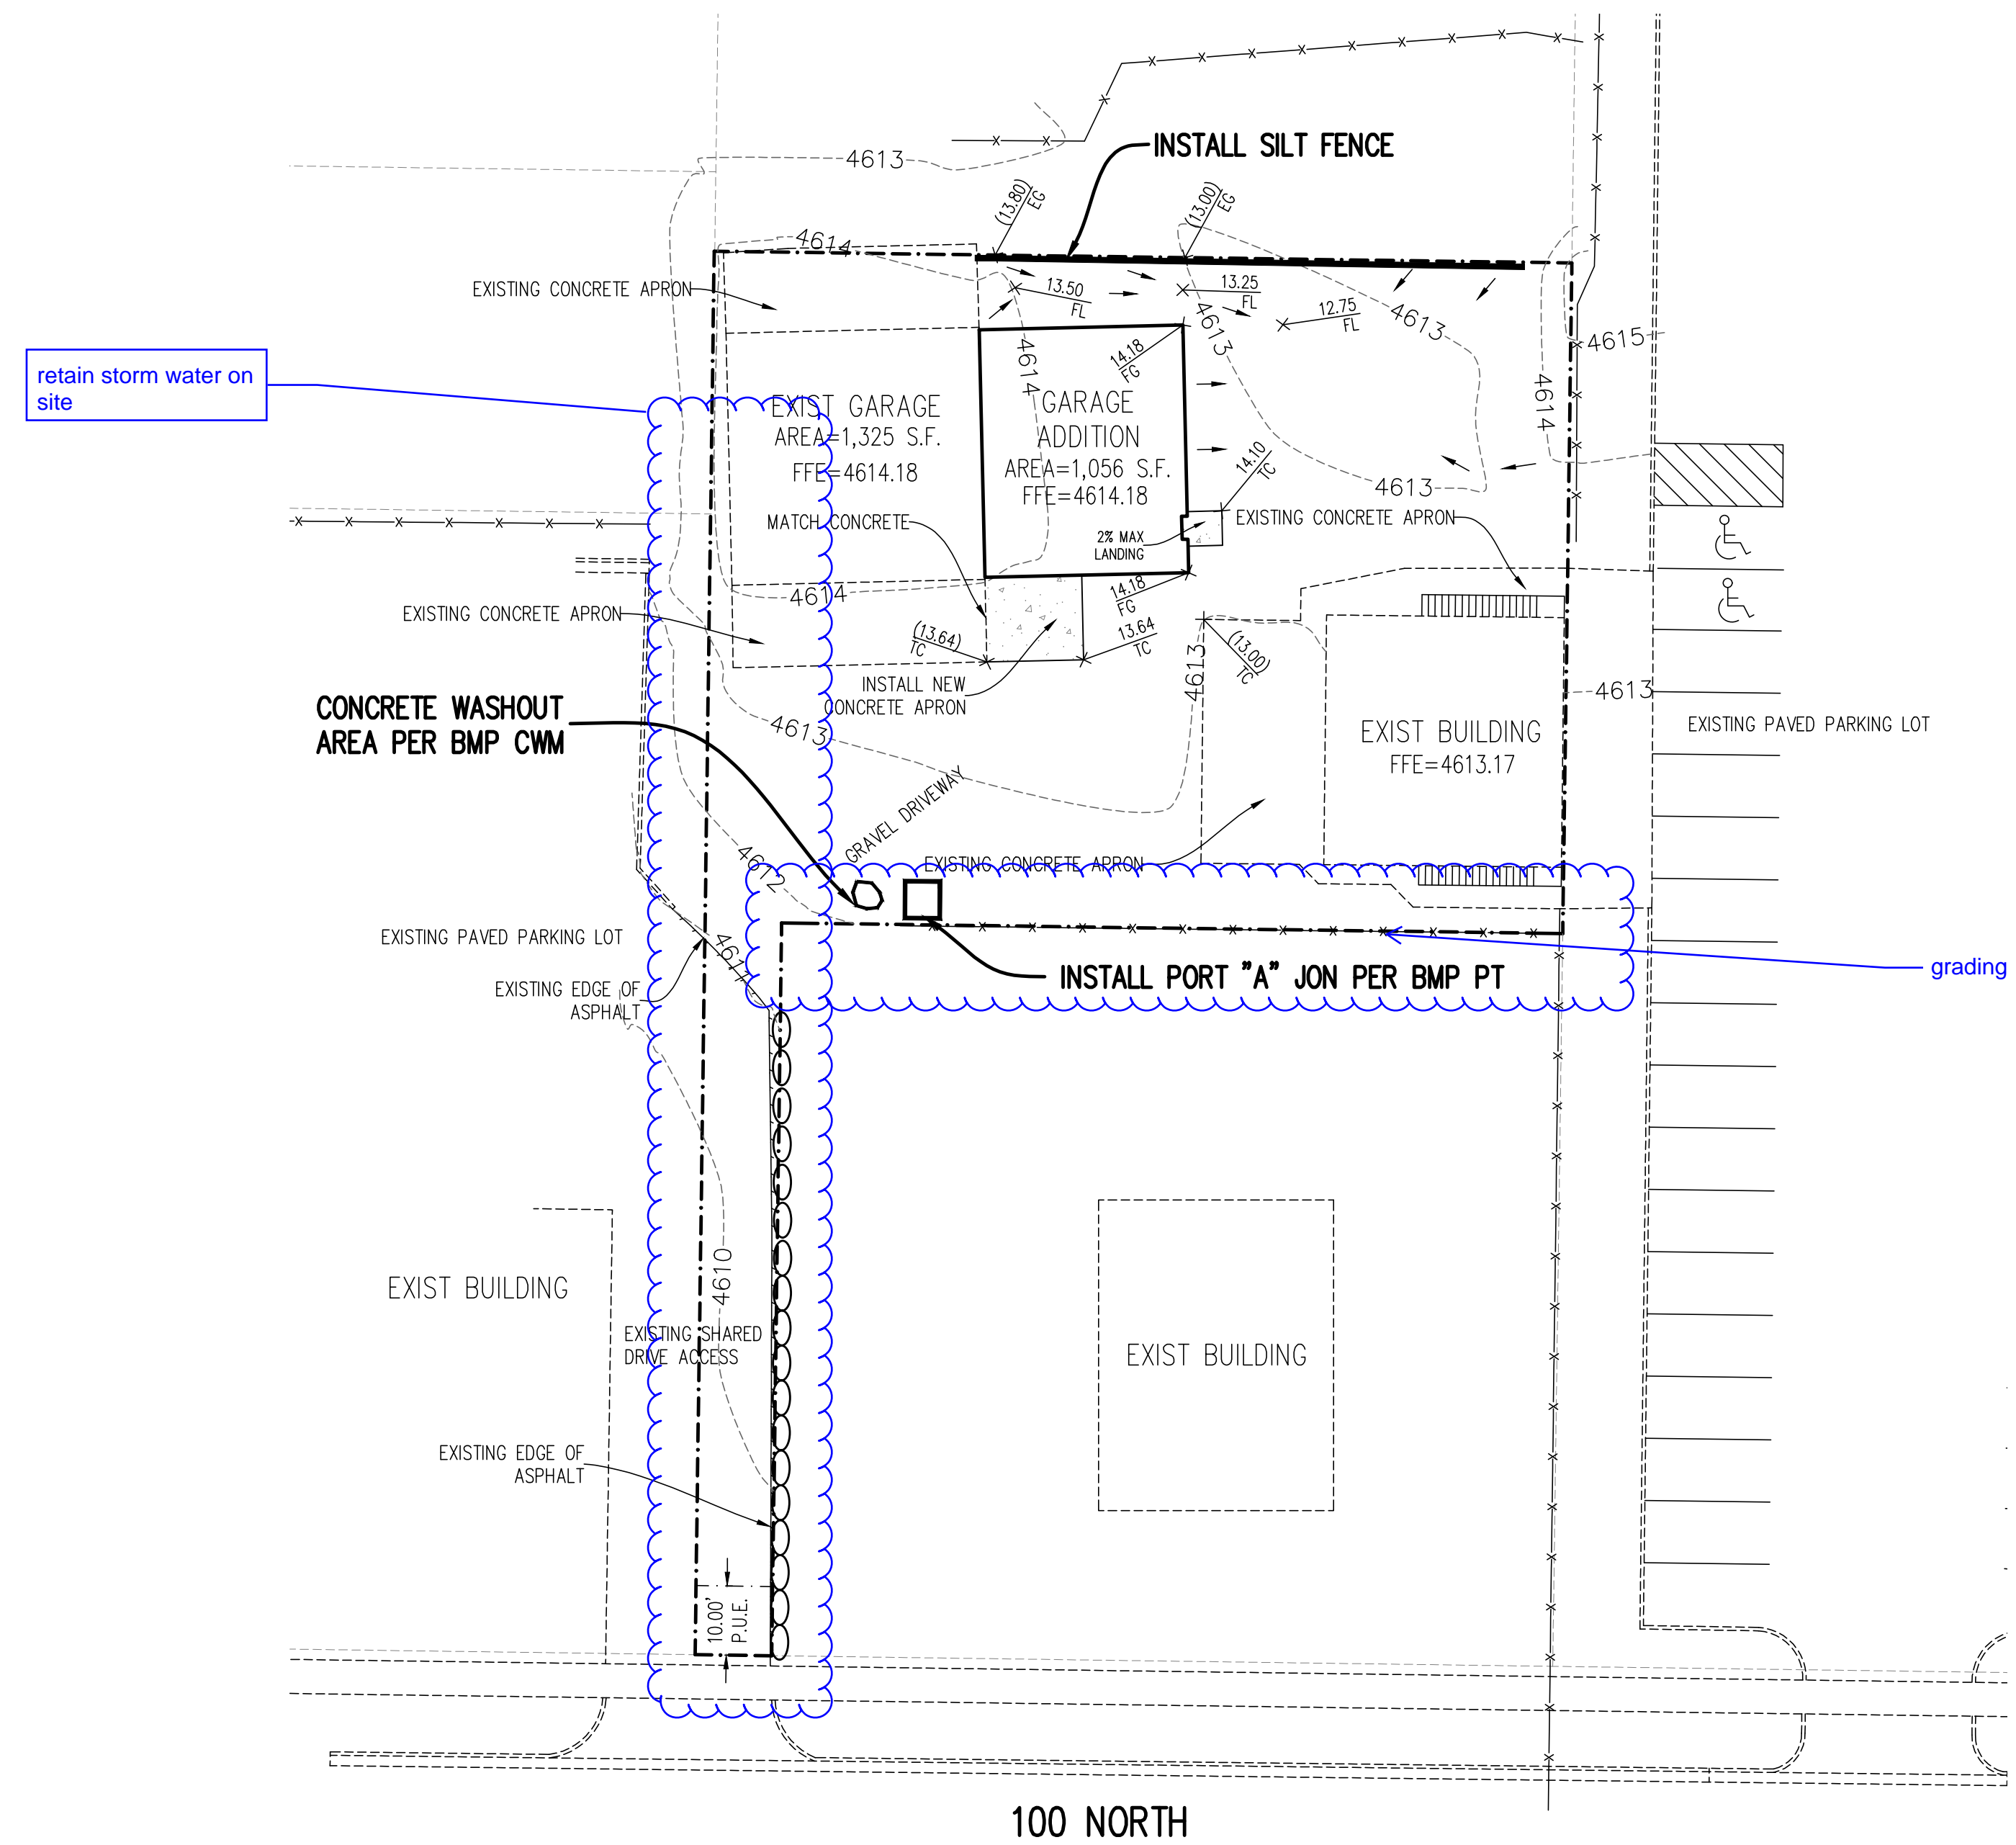


EROSION CONTROL NOTES:

1. CONSTRUCT A SILT FENCE AS SHOWN ON PLAN. SEE BMP SF.
2. INSTALL CONCRETE WASH OUT AREA. SEE BMP CWM
3. INSTALL PORTABLE TOILET. SEE BMP PT
4. CONTRACTOR WILL BE RESPONSIBLE FOR THE IMPLEMENTATION AND MAINTENANCE OF BMP'S DURING CONSTRUCTION.

SWPPP CONTACT LIST:

COMPANY	CONTACT	PHONE
AF STORM DRAIN SEWER	Ashton Hardy	(801) 404 6162
AF STORM WATER INSPECTOR	Harlan Nielson	(801) 404 6361
AF FLOOD IRRIGATION COMPANY	Ernie Johns	(801) 756 6626
TIMPANOGOS SPECIAL SERVICE DISTRICT	Jon Adams	(801) 756 5231

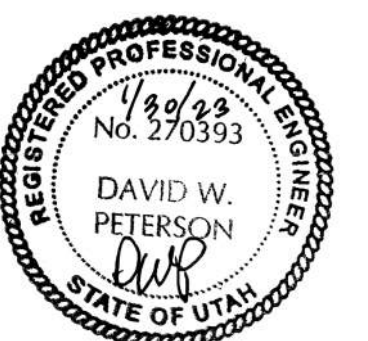


SURVEYOR:
LEVEL OF FOCUS, INC
1334 East 1150 South
Spanish Fork, Utah 84660
(801) 319-5441

BENCH MARK	REVISIONS		
	Rev.	Date	Description
SOUTH QUARTER CORNER, SECTION 14, TOWNSHIP 5 SOUTH, RANGE 1 EAST, SALT LAKE BASE AND MERIDIAN ELEVATION = 4594.27 (NGVD 29 DATUM) NAVD 88 IS 3.6' HIGHER THAN NGVD 29			


Developer: ADAM ANDERSON
95 EAST 200 NORTH, AMERICAN FORK, UT 801-763-8813



ANDERSON GARAGE ADDITION		
AMERICAN FORK	33 EAST 100 NORTH	UTAH
Drawn by: D.W.P.	GRADING & EROSION CONTROL PLAN	Scale: 1"=20'
Designed by: D.W.P.		Date: 01/30/23
Checked by: D.W.P.		C2

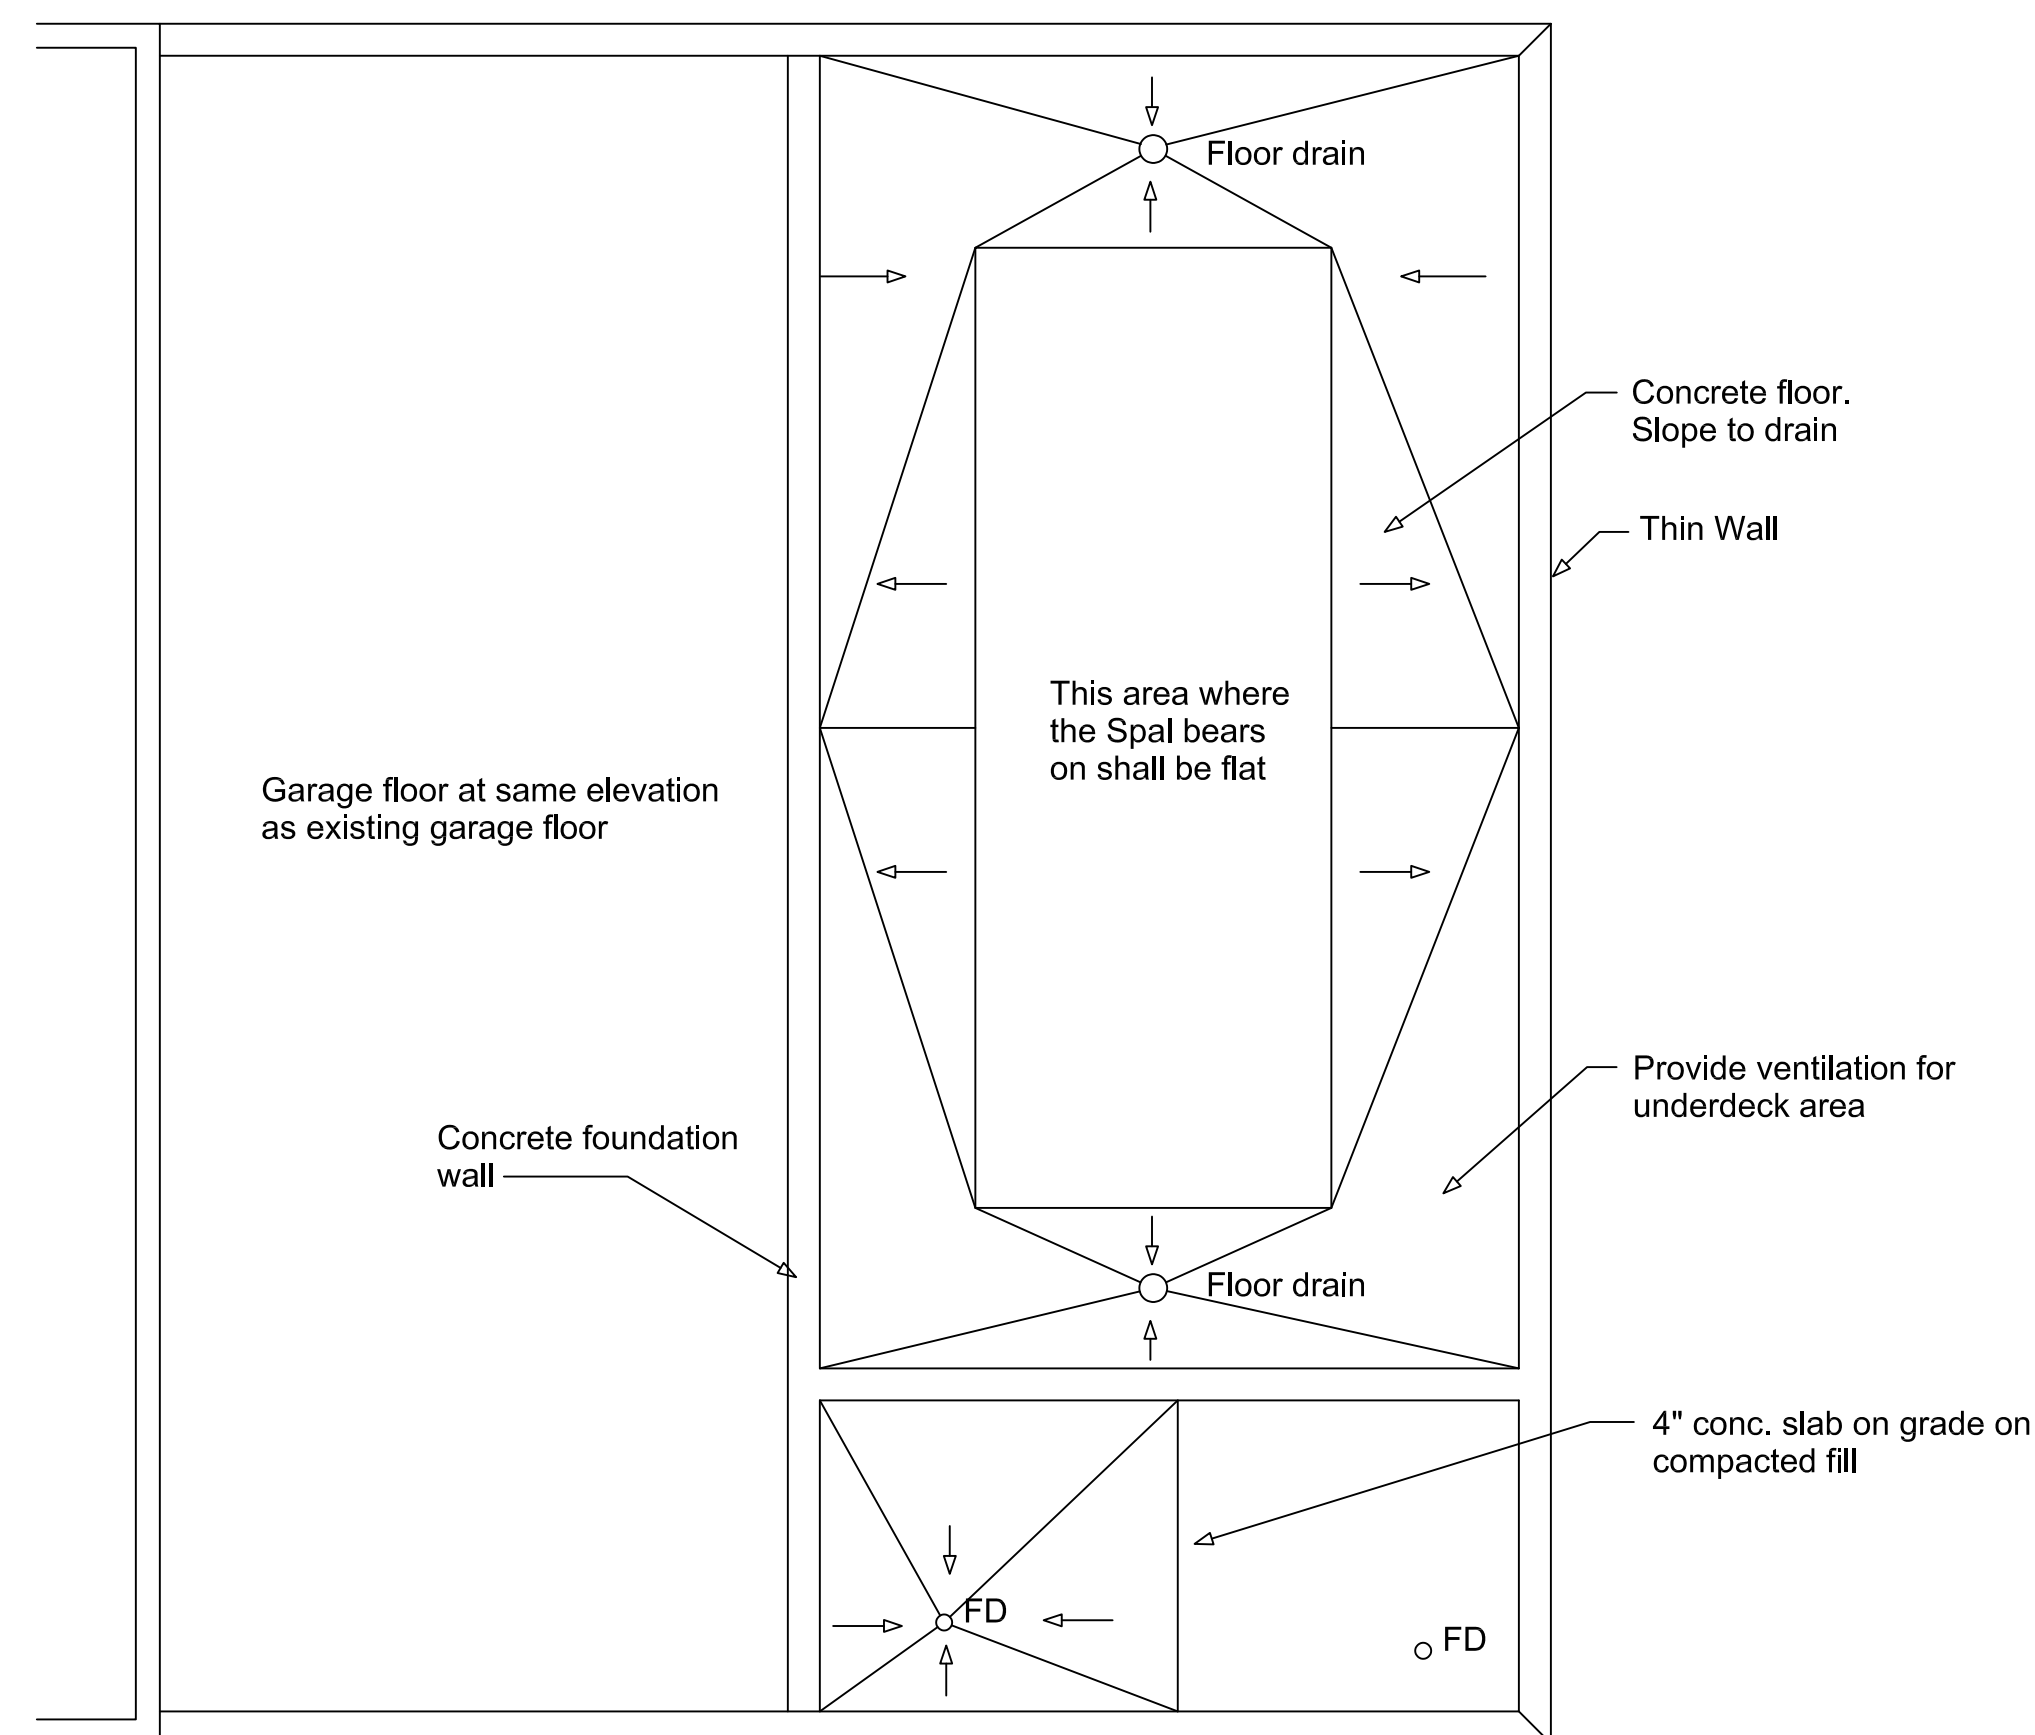


Below Deck Plan

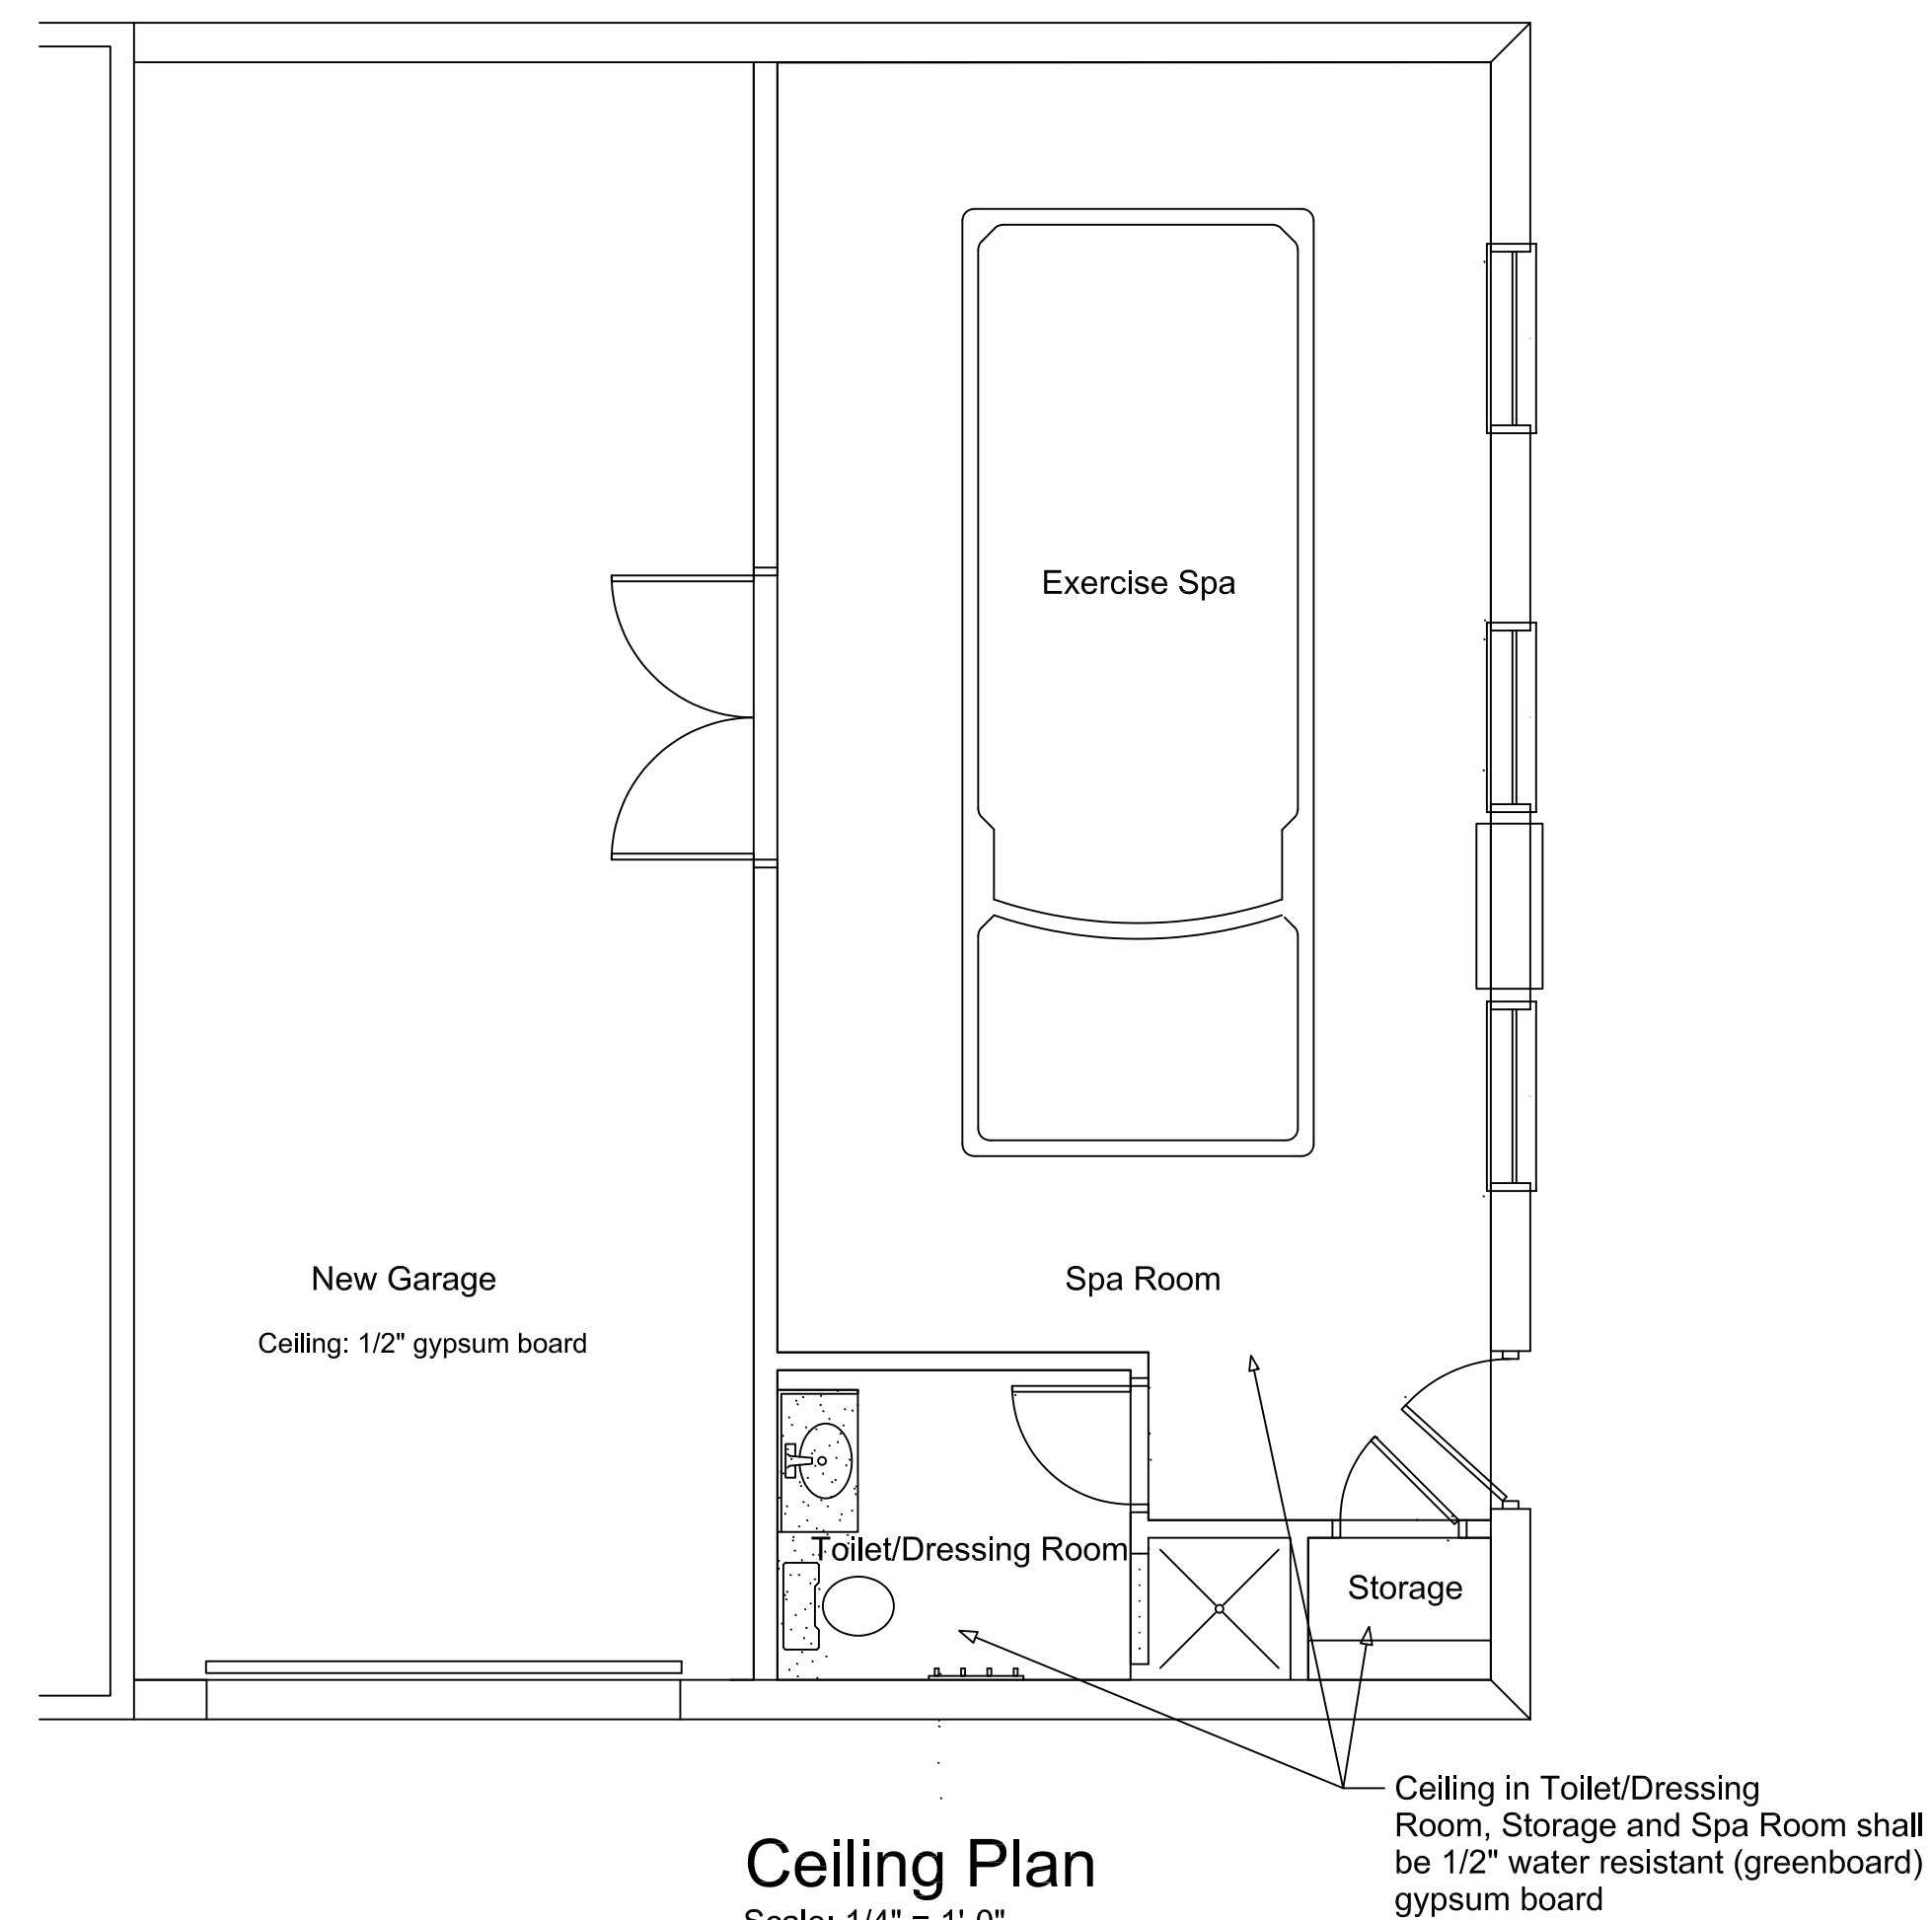


Ceiling Plan

Scale: 1/4" = 1'-0"

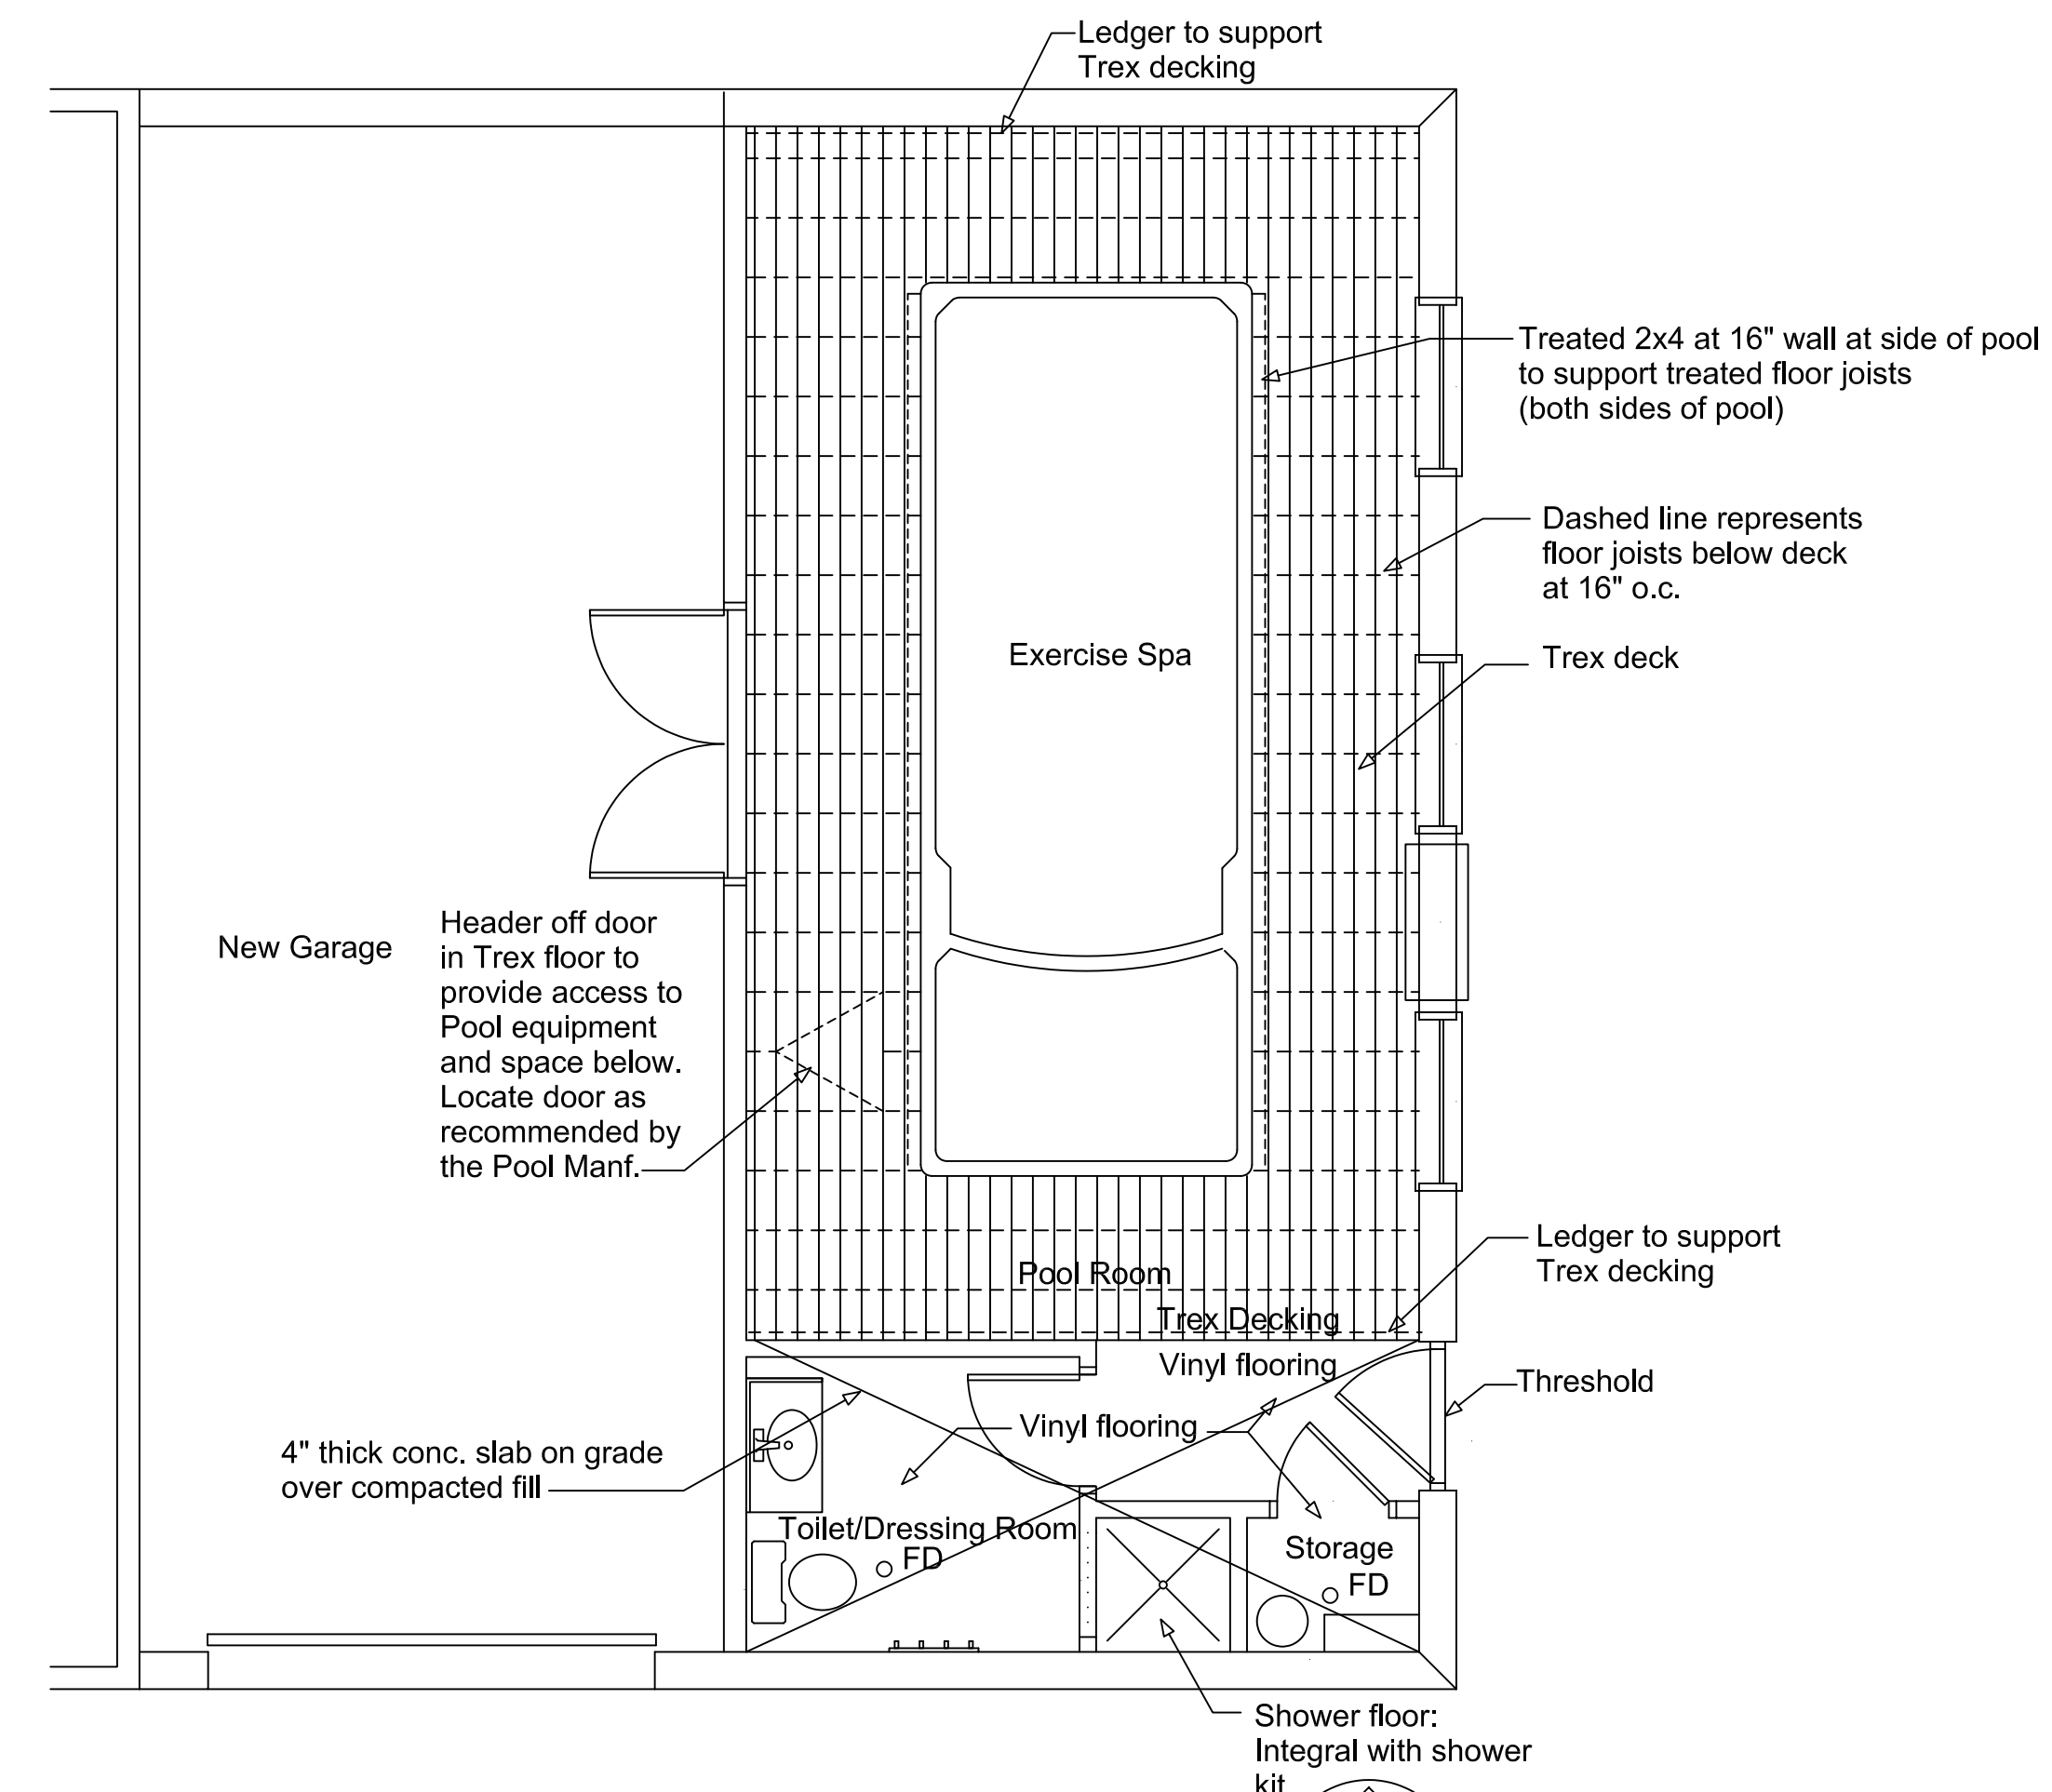

Floor Finishes Plan

Scale: 1/4" = 1'-0"

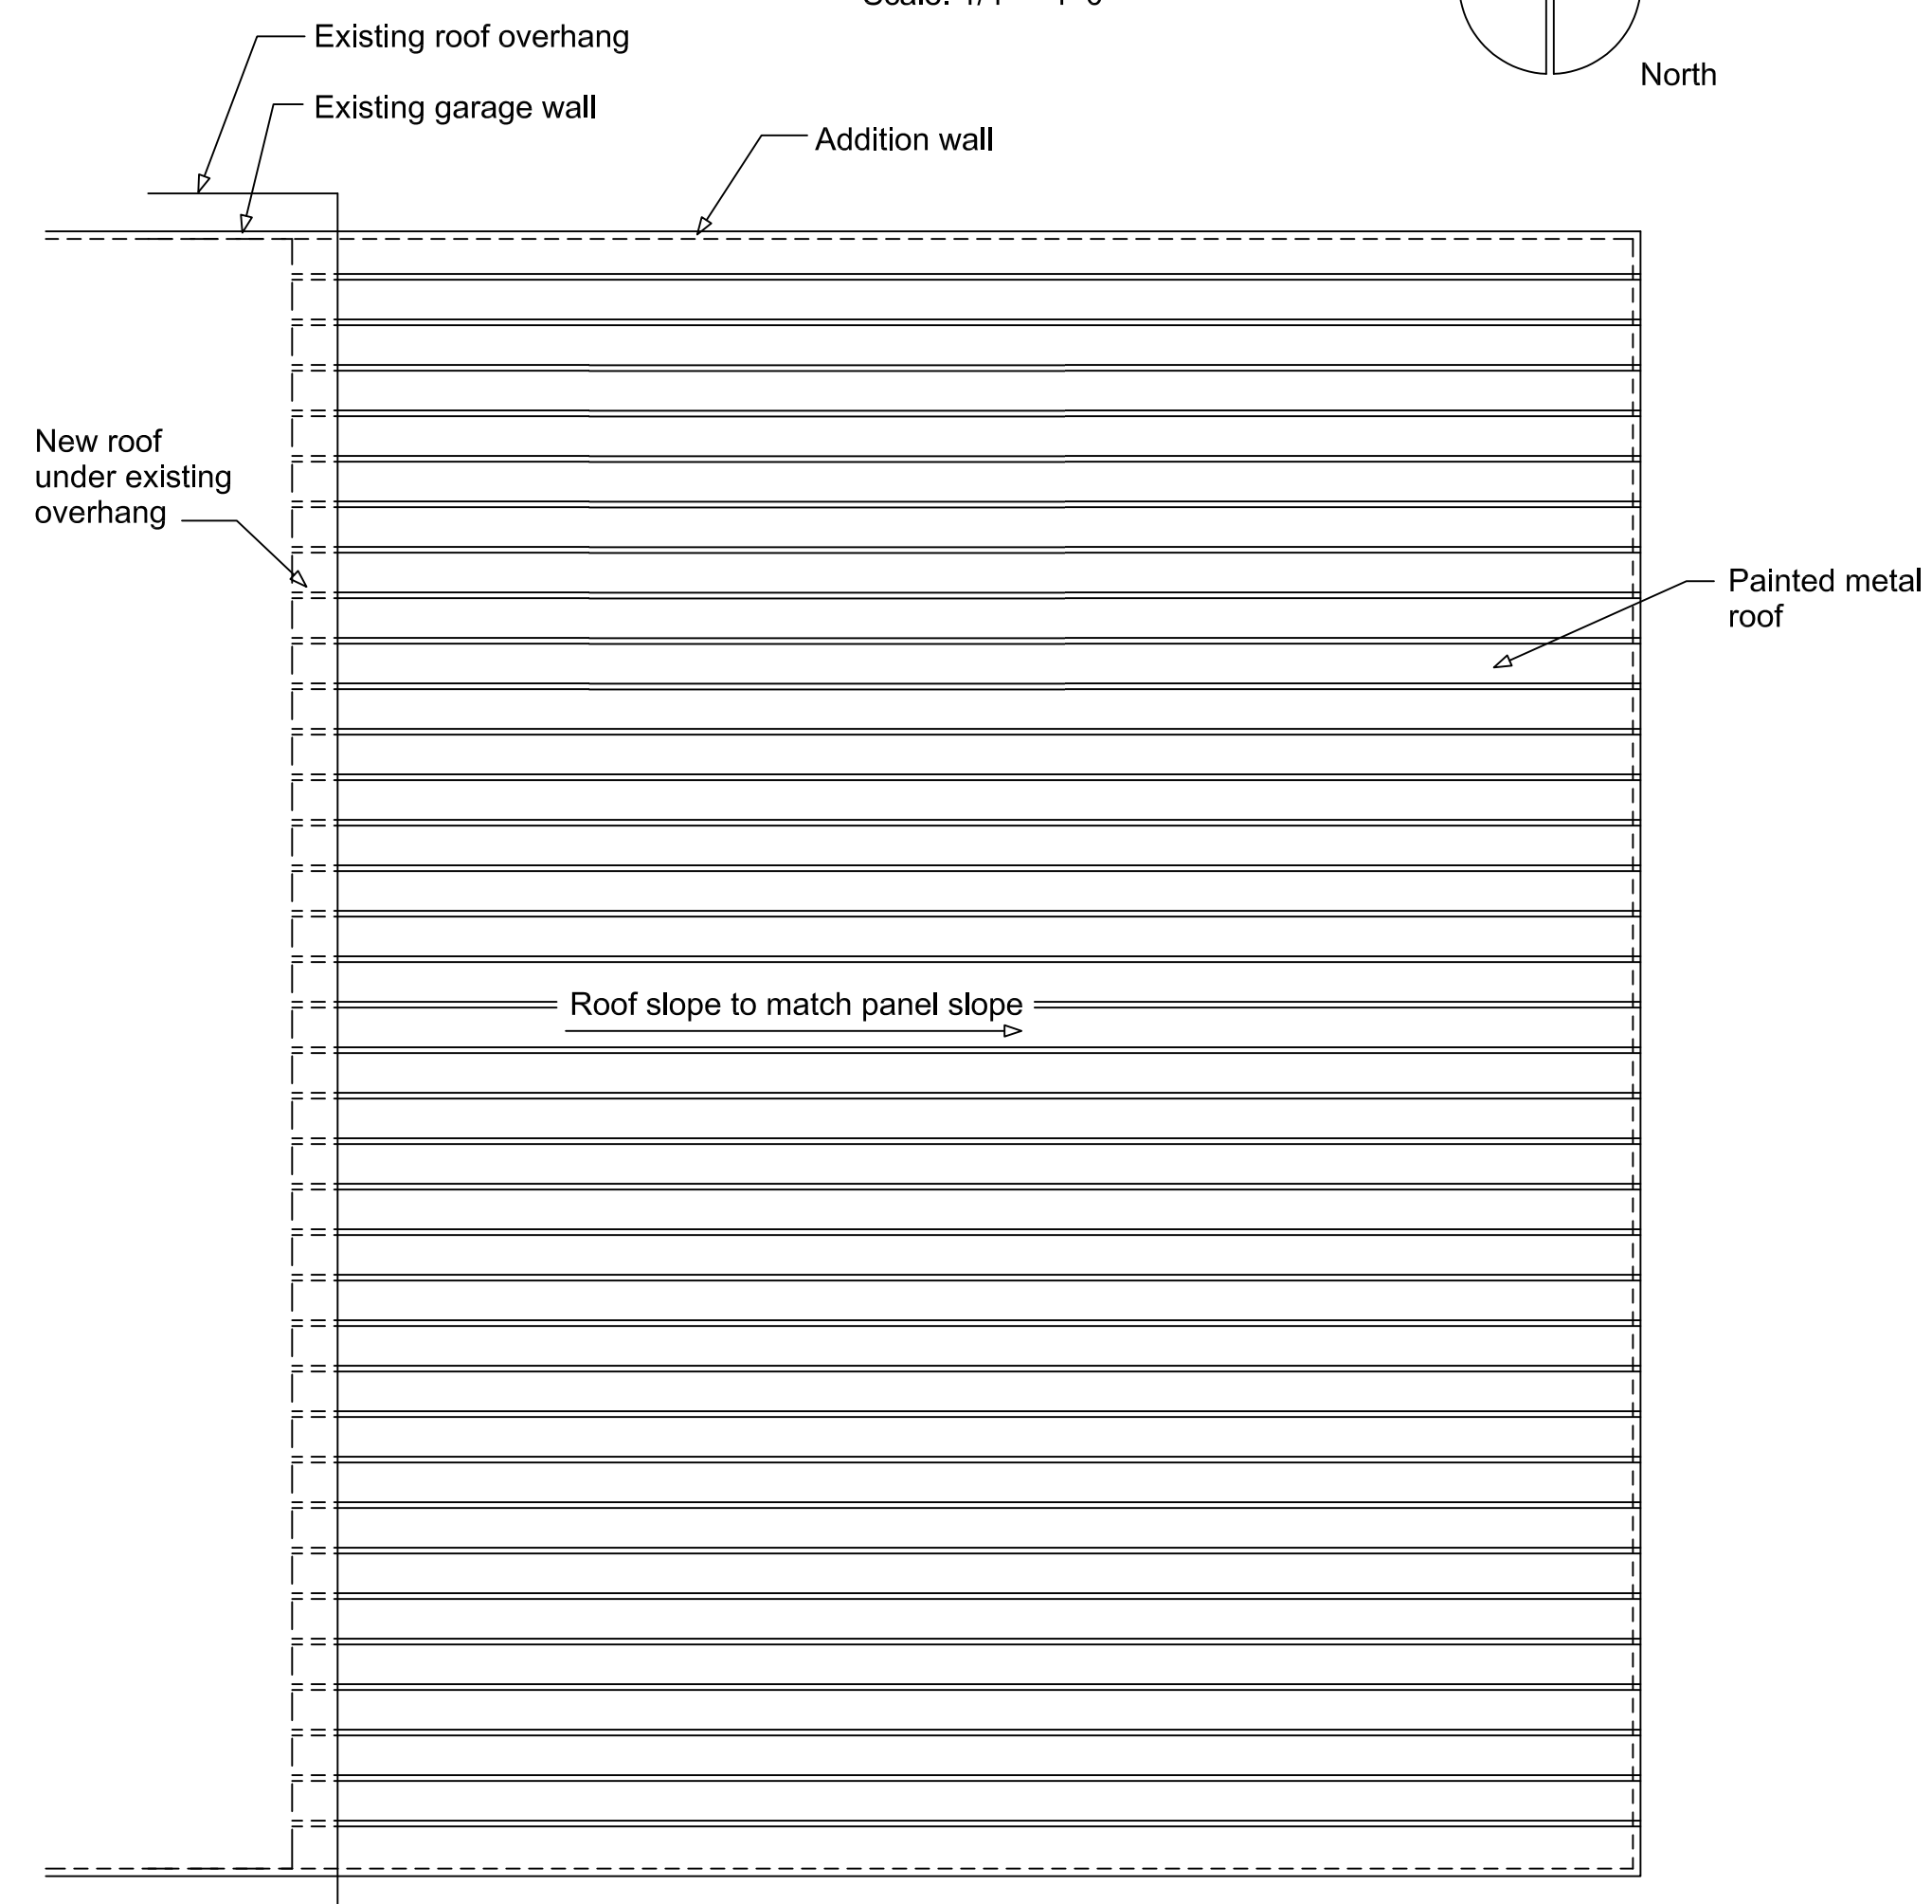

Roof Plan

Scale: 1/4" = 1'-0"

RatherArchitecture
Professional Corporation


1091 W South Jordan Parkway Suite 250
South Jordan, UT 84095

phone: 801 232-3638
email: john@ratherarchitecture.com

CONTRACTOR

PROJECT and OWNER

ADAM ANDERSON
Garage and Exercise Spa Addition
33 East 100 North
American Fork, UT 84002

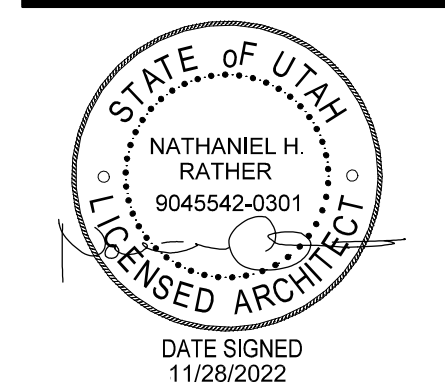[illegible]

Floor Finishes,
Below Deck,
Ceiling Plan and
Roof Plan

Project number	1417.175.02
Date Started	29 Sep 2021
Drawn by	JDR
Checked by	NHR


A102

Scale As indicated



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Project number	1417.175.02
Date Started	29 Sep 2021
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Scale As indicated





Note:
The location of the Thin Wall joints are approximate. The manufacturer of the Thin Wall panel in coordination with the Contractor shall determine the exact location of the panel joints.

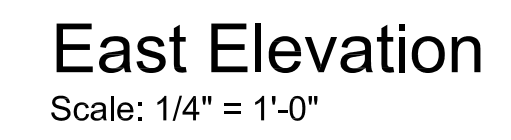

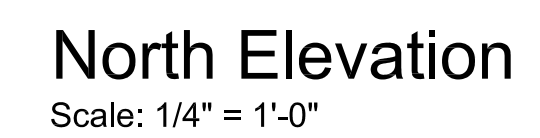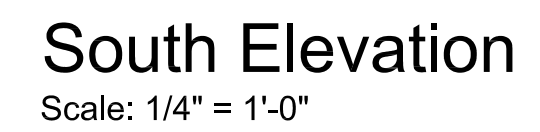

Project number	1417.175.02
Date Started	29 Sep 2021
Drawn by	JDR
Checked by	NHR

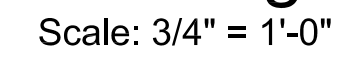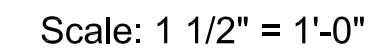

MECHANICAL GENERAL NOTES

CODES RULES AND REGULATIONS:

ALL WORK SHALL CONFORM TO ALL APPLICABLE LOCAL AND STATE CODES.

WHENEVER INDICATED MATERIAL WORKMANSHIP, ARRANGEMENT OR CONSTRUCTION IS OF HIGHER QUALITY OR CAPACITY THAN THAT REQUIRED BY THE ABOVE CODES, THE DRAWING AND OR SPECIFICATION SHALL GOVERN.

SHOULD THERE BE ANY DIRECT CONFLICT BETWEEN THE STATE OR LOCAL CODES, LAWS OR REGULATION AND THE DRAWING AND OR SPECIFICATIONS THE CODES, LAWS OR REGULATIONS SHALL GOVERN.

STANDARDS:

- INTERNATIONAL BUILDING CODE 2018 EDITION
- INTERNATIONAL PLUMBING CODE 2018 EDITION
- INTERNATIONAL MECHANICAL CODE 2018 EDITION
- INTERNATIONAL FUEL GAS CODE 2018 EDITION
- SMACNA DUCT CONSTRUCTION STANDARD, METAL AND FIBERGLASS
- SMACNA FIRE DAMPER GUIDE FOR AIR HANDLING SYSTEMS
- SMACNA MANUAL FOR BALANCING AND ADJUSTING OF AIR DISTRIBUTION SYSTEMS.
- SMACNA GUIDELINES FOR SEISMIC RESTRAINTS OF MECHANICAL EQUIPMENT
- NFPA 101 LIFE SAFETY CODES.
- NFPA 90A INSTALLATION OF AIR CONDITIONING AND VENTILATION SYSTEMS.
- NFPA 90B INSTALLATION OF WARM AIR HEATING SYSTEMS.
- NFPA 91 INSTALLATION OF BLOWER AND EXHAUST SYSTEMS
- THE STATE OF UTAH " BOILER AND PRESSURE VESSEL REGULATIONS"

EXAMINATION OF SITE:

THE CONTRACTOR SHALL CAREFULLY EXAMINE THE DRAWINGS AND THE SITE AND FAMILIARIZE THEMSELVES WITH ALL EXISTING CONDITIONS BEFORE SUBMITTING ANY PROPOSAL. NO ADDITION COST WILL BE ALLOWED FOR FAILURE TO VISIT THE SITE.

WORKING DRAWINGS AND MEASUREMENTS:

THESE DRAWINGS ARE GENERALLY DIAGRAMMATIC. THEY DO NOT SHOW EVER OFFSET AND BEND THAT MAY BE NEEDED TO INSTALL THE WORK. THE CONTRACTOR SHALL COORDINATE THE DRAWINGS OF ALL OTHER TRADES INCLUDING BUT NOT LIMITED TO THE CIVIL, ARCHITECTURAL, ELECTRICAL, AND STRUCTURAL. THESE DRAWINGS SHALL NOT BE SCALED FOR ROUGH IN OR AS SHOP DRAWINGS.

MECHANICAL GENERAL NOTES

EQUIPMENT SUBMITTALS:

PROVIDE ALL AT ONE TIME IN A THREE RING BINDER SIX COPIES OF EQUIPMENT PROPOSED TO BE USED ON THIS PROJECT.

REGARDLESS OF ANY INFORMATION OUTLINED IN THE SUBMITTALS OR SHOP DRAWINGS, THE REQUIREMENTS OF THE DRAWINGS MUST FOLLOWED AND ARE NOT WAIVED OR SUPERSEDED IN ANY WAY BY THE SUBMITTALS OR SHOP DRAWING REVIEW.

CAULKING AND SEALING:

ALL SPACES BETWEEN DUCTS AND SLEEVES THROUGH FIRE WALLS, FIRE PARTITIONS, FLOORS, AND CEILINGS SHALL CAULKED WITH ONE INCH FILL OF 3M "FIRE BARRIER". CAULKING MUST BE ON BOTH SIDES OF FIRE RATED WALLS.

SUPERVISION AND WORKMANSHIP:

PROVIDE THE SERVICES OF AN EXPERIENCED FORMAN WHO SHALL BE IN CHARGE OF ALL INSTALLATION.

ALL WORKMANSHIP SHALL BE OF FIRST QUALITY. NONE BUT COMPETENT MECHANICS SHALL BE EMPLOYED IN THE WORK. SHODDY WORKMANSHIP WILL BE CAUSE FOR REJECTION AND REPLACEMENT OF WORK WITHOUT ADDITIONAL COST.

COOPERATION WITH OTHER TRADES:

REFER TO ALL THE DRAWINGS COVERING WORK OF ALL TRADES, WHICH IS CARRIED ON IN CONJUNCTION WITH THE WORK SUCH THAT ALL WORK CAN PROCEED WITHOUT INTERFERENCE RESULTING FROM LACK OF COORDINATION.

MANUFACTURERS INSTRUCTIONS:

THE CONTRACTOR SHALL FOLLOW THE MANUFACTURERS INSTALLATION INSTRUCTION EXPLICITLY IN THE INSTALLATION OF ALL ITEMS OF EQUIPMENT.

COMPLETION REQUIREMENTS:

ALL SYSTEMS SHALL BE TESTED BY THE CONTRACTOR TO DEMONSTRATE THE ALL EQUIPMENT FURNISHED ARE INSTALLED OR CONNECTED FUNCTION IN THE MANNER REQUIRED.

ADJUSTMENTS, OPERATION, ETC. ADJUST ALL REGULATORS. OPEN AND CLOSE ALL VALVES SEVERAL TIMES TO INSURE SEAL.

MECHANICAL GENERAL NOTES

CLEANING:

REMOVE DEBRIS AND TRASH FROM DUCTWORK AND VACUUM IF REQUIRED. PAINT INSIDE OF ALL DUCTS VISIBLE THROUGH GRILLES AND REGISTERS WITH FLAT BLACK ENAMEL. REMOVE SHIPPING LABELS AND OTHER TAGS AND WIPE ALL EQUIPMENT CLEAN.

TESTING AND BALANCING:

AT THE COMPLETION OF THE JOB THE CONTRACTOR SHALL RETAIN THE SERVICES OF AN INDEPENDENT TESTING AND BALANCING CONTRACTOR. PROVIDE ALL TOOLS, EQUIPMENT AND INSTRUMENTS REQUIRED FOR THE TEST AND BALANCING PROCEDURES. TEST AND BALANCE BOTH THE AIR SYSTEMS AND THE HYDRAULIC SYSTEMS.

SUBMIT 4 COPIES OF COMPLETE TEST AND BALANCING REPORTS, COMPLETE WITH HALF SCALE DRAWINGS INDICATING THE AIR OPENING NUMBERS AND FLOW STATION NUMBERS THAT CORRESPOND TO THE NUMBERING SYSTEMS IN THE REPORTS

IDENTIFY AND LIST SIZE TYPE AND MANUFACTURER OF ALL EQUIPMENT. MAKE ALL ADJUSTMENTS TO DAMPERS, DRIVES AND BALANCE VALVES TO OBTAIN THE DESIGN FLOW QUANTITIES. FLOW QUANTITIES SHALL BE WITHIN PLUS OR MINUS 5 % OF DESIGN.

GUARANTEE:

BY THE ACCEPTANCE OF AN CONTRACT AWARD FOR THE WORK HERE IN DESCRIBED OR SHOWN ON THE DRAWINGS, THE CONTRACTOR ASSUMES THE FULL RESPONSIBILITY IMPOSED BY THE GUARANTEE AS SET FORTH HEREIN, AND SHALL PROTECT HIMSELF THROUGH PROPER GUARANTEES FROM EQUIPMENT VENDORS AND FROM SUBCONTRACTORS AS THEIR INTERESTS MAY APPEAR.

1. THAT THE ENTIRE MECHANICAL SYSTEMS SHALL BE QUIET IN OPERATION.
2. THAT THE CIRCULATION OF WATER SHALL BE COMPLETE AND EVEN INCLUDING THE DOMESTIC HOT WATER SYSTEM.
3. THAT HE WILL MAKE PROMPTLY UPON NOTICE, FREE OF CHARGE, ANY REPAIRS NECESSARY DUE TO DEFECTIVE MATERIALS OR MATERIALS OR WORKMANSHIP THAT MAY OCCUR DURING A PERIOD OF ONE YEAR FROM THE DATE OF SUBSTANTIAL COMPLETION. FIVE YEARS FOR AIR CONDITIONING COMPRESSORS.

MECHANICAL INSULATION SCHEDULE

NOTES:

ALL INSULATION SHALL HAVE SURFACE BURNING CHARACTERISTICS, AS TESTED BY ASTM E84, UL723 OR NFPA 255 NOT EXCEEDING : FLAME SPREAD 25 AND SMOKE DEVELOPED 50.

COMPOSITE SHEET INCLUDE INSULATION JACKETING AND ADHESIVES USE TO SECURE JACKETING OR FACING. ALL ACCESSORY ITEMS SUCH AS PVC JACKETING AND FITTINGS, ADHESIVES, MASTIC, CEMENT, TAPE AND CLOTH SHALL HAVE SAME COMPONENT RATING AS ABOVE.

THERMAL DUCT WRAP:

FIBERGLASS BLANKET INSULATION: THERMAL CONDUCTIVITY OF 0.28 BTU-IN/PER SQ FT PER HOUR AT 75 DEG F MEAN TEMPERATURE. MINIMUM DENSITY OF ONE POUND PER CUBIC FOOT. JACKETED WITH ALUMINUM FOIL REINFORCED WITH FIBERGLASS SCRIM LAMINATED KRAFT FACING.

THERMAL DUCT WRAP INSTALLATION:

WRAP ALL SUPPLY, RETURN, AND OUTSIDE AIR WITH 1-1/2" DUCT WRAP IN ACCORDANCE WITH MANUFACTURERS INSTALLATION INSTRUCTIONS. DUCT THAT ARE INTERNALLY LINED NEED NOT BE WRAPPED.

DUCTWORK IN UNCONDITIONED SPACES

ALL DUCTWORK RUNNING THROUGH UNCONDITIONED SPACES MUST HAVE A MINIMUM R-12 INSULATION.

SYMBOL LEGEND

SYMBOL	DESCRIPTION
	SUPPLY AIR (S.A.)
	RETURN AIR (R.A.)
	TURNING VANES
	MANUAL DAMPER
	FIRE DAMPER
	SMOKE DAMPER
	EXISTING DUCTWORK

GENERAL NOTES

COORDINATE ALL SUSPENDED EQUIPMENT WITH ARCHITECTURAL REFLECTED CEILING PLAN.

IT IS THE RESPONSIBILITY OF THE MECHANICAL CONTRACTOR TO COORDINATE HIS WORK WITH ALL OTHER TRADES.

COORDINATE ALL ROOF MOUNTED MECHANICAL EQUIPMENT WITH STRUCTURAL PLANS. THE MECHANICAL CONTRACTOR SHALL BE RESPONSIBLE FOR ADDITIONAL STRUCTURE REQUIRED TO SUPPORT THE EQUIPMENT IF EQUIPMENT WEIGHT AND DIMENSIONS EXCEED WHAT HAS BEEN SCHEDULED AND SHOWN ON THE DRAWINGS.

COORDINATE ALL ROOF PENETRATIONS WITH STRUCTURAL DRAWINGS.

ALL DUCT SIZES ARE CLEAR INSIDE DIMENSIONS. INCREASE SIZES AS REQUIRED FOR DUCT LINER.

ALL EQUIPMENT DESIGNED TO BE FIXED IN POSITION SHALL BE SECURELY FASTENED IN PLACE.

ALL QUESTION MUST BE SUBMITTED TO THE ARCHITECT IN THE FORM OF AN RFI. ANY RFI SENT DIRECTLY TO ENGINEER WILL BE RETURNED UNREAD.

ANY RFIs THAT HAVE BEEN CORRECTED OR APPROVED BY THE ENGINEER WILL BE JUST FOR CLARIFICATION, AND DOES NOT CONSTITUTE A CHANGE ORDER.

CHANGE ORDERS MUST BE SUBMITTED TO THE ARCHITECT. THE CHANGE ORDER SHALL BE COMPLETE BY LISTING THE FINAL PRICING WITH PROPER BREAKDOWN AND DOCUMENTATION. POSSIBLE TIME EXTENSION OR DELAY AND THE ASSOCIATED COST FOR THE TIME EXTENSION OR DELAY. MATERIAL AND LABOR COST.

RFIs WITH BE RETURNED TO ARCHITECT FROM ENGINEER WITHIN 5 WORKING DAYS.

CHANGE ORDERS WILL BE RETURNED TO ARCHITECT FROM ENGINEER WITHIN 15 DAYS.

DO NOT PROCEED WITH RFI UNTIL CHANGE ORDER HAS BEEN APPROVED BY ARCHITECT, OWNER AND ENGINEER. IF CONTRACTOR DOES SO IT WILL BE AT THERE OWN RISK.

IF TIME EXTENSIONS AND/OR DELAYS ARE INCURRED DUE TO FAILURE TO ISSUE AN RFI, CHANGE REQUEST, CHANGE ORDER, OR IMPROPER AND/OR INCOMPLETE DOCUMENTATION THE COST ASSOCIATED WITH THE DELAY WILL BE BORNE BY THE CONTRACTOR.

MECHANICAL CALLOUT

The diagram illustrates the MECHANICAL CALLOUT system. It features a legend at the top with a symbol for 'EF-6 600' (a rectangle with a horizontal line) representing 'EQUIPMENT' and 'SYMBOL CAPACITY'. Below this, a list of equipment types is provided: CU (CONDENSING UNIT), DH (DEHUMIDIFIER), EWH (ELECTRIC WALL HEATER), EF (EXHAUST FAN), UH (UNIT HEATER), CDR (ROUND CONE DIFFUSER), and SWR (SIDEWALL RETURN AIR GRILLE). A separate legend shows a symbol for '9x9.4 CD 175' (a rectangle with a horizontal line) representing 'DIFFUSER OR GRILLE', with 'SIZE' and 'TYPE' indicated for the top part and 'PATTERN' and 'CFM' indicated for the bottom part.

SEISMIC BRACING SUBMITTAL REQUIREMENTS

THE CONTRACTOR SHALL BE RESPONSIBLE FOR THE DESIGN AND INSTALLATION OF ALL REQUIRED SEISMIC BRACING BY THE 2018 INTERNATIONAL BUILDING CODE, SECTION 1615 EARTHQUAKE LOADS. PARAGRAPH 1613.1 SCOPE. RESTRAINT MUST BE PROVIDED FOR THE FOLLOWING CONDITIONS, UNLESS OTHERWISE EXCLUDED BY CHAPTER 13 OF ASCE 7-10: (1) $I_p \geq 1.0$, (2) MEP COMPONENTS > 400 POUNDS AND SUPPORTED BY A FLOOR OR ROOF; (3) MEP COMPONENTS > 20 POUNDS AND SUPPORTED BY A CEILING OR WALL; OR (4) MEP DISTRIBUTION SYSTEM WEIGHING > 5 PLF.

THE CONTRACTOR SHALL PROVIDE A COMPLETE SUBMITTAL FOR ALL MEP EQUIPMENT TO INCLUDE LOCATION OF EACH SEISMIC BRACE, TYPE AND DESIGN OF THE BRACING, AND A DETAIL OF THE SEISMIC BRACING. THE SUBMITTAL SHALL BE ON 36"x24" SHEETS AND A SCALE OF 1/4" = 1'-0", ALONG WITH A COMPLETE SET OF CALCULATIONS.

THE SUBMITTAL SHALL CLEARLY INDICATE WHICH ITEMS ARE REQUIRED TO BE BRACED AND THE MINIMUM BRACING REQUIREMENTS (E.G. PER IRC 103.1 AND CHAPTER 13 OF ASCE 7-10). IN ADDITION THE SUBMITTAL SHALL BE PROVIDED BY A LICENCED PROFESSIONAL ENGINEER LICENCED IN UTAH.

UNDER NO CONDITIONS SHALL ANY MECHANICAL OR ELECTRICAL COMPONENTS BE INSTALLED UNTIL SUCH TIME AS THE AMERICAN FORK CITY BUILDING DEPARTMENT HAS REVIEWED AND APPROVED THE SUBMITTAL.

SEISMIC BRACING SUBMITTAL REQUIREMENTS

THE CONTRACTOR SHALL BE RESPONSIBLE FOR THE DESIGN AND INSTALLATION OF ALL REQUIRED SEISMIC BRACING BY THE 2018 INTERNATIONAL BUILDING CODE. SECTION 1613.1 EARTHQUAKE LOADS. PARAGRAPH 1613.1 SCOPE. RESTRAINT MUST BE PROVIDED FOR THE FOLLOWING CONDITIONS, UNLESS OTHERWISE EXCLUDED BY CHAPTER 13 OF ASCE 1-10: (1) IPR 1.0. (2) MEP COMPONENTS > 400 POUNDS AND SUPPORTED BY A FLOOR OR ROOF. (3) MEP COMPONENTS > 20 POUNDS AND SUPPORTED BY A CEILING OR WALL. OR (4) MEP DISTRIBUTION SYSTEM WEIGHING > 5 PLF.

THE CONTRACTOR SHALL PROVIDE A COMPLETE SUBMITTAL FOR ALL MEP EQUIPMENT TO INCLUDE LOCATION OF EACH SEISMIC BRACE, TYPE AND DESIGN OF THE BRACING, AND A DETAIL OF THE SEISMIC BRACING. THE SUBMITTAL SHALL BE ON 36"x24" SHEETS AND A SCALE OF 1/4" = 1'-0". ALONG WITH A COMPLETE SET OF CALCULATIONS.

THE SUBMITTAL SHALL CLEARLY INDICATE WHICH ITEMS ARE REQUIRED TO BE BRACED AND THE MINIMUM BRACING REQUIREMENTS (E.G. PER IBC 103.1 AND CHAPTER 13 OF ASCE 1-10). IN ADDITION THE SUBMITTAL SHALL BE PROVIDED BY A LICENCED PROFESSIONAL ENGINEER LICENCED IN UTAH.

UNDER NO CONDITIONS SHALL ANY MECHANICAL OR ELECTRICAL COMPONENTS BE INSTALLED UNTIL SUCH TIME AS THE AMERICAN FORK CITY BUILDING DEPARTMENT HAS REVIEWED AND APPROVED THE SUBMITTAL.

[illegible]

Project number	1417.175.02
Date Started	Feb. 15, 2022
Drawn by	DBH
Checked by	DRW

Scale As indicated



UNIT HEATER SCHEDULE			
UNIT DATA			
SYMBOL		UH-1	
MANUFACTURER		REZNOR	
MODEL NUMBER		UD3 30	
PERFORMANCE			
INPUT HEATING CAPACITY	BTUH	30,000	
	kw/h	8.8	
THERMAL EFFICIENCY	%	82%	
OUTPUT HEATING CAPACITY	BTUH	24,600	
	kw/h	7.2	
GAS CONNECTION	NATURAL	1/2"	
VENT CONNECTION	DIA.	4"	
COMBUSTION AIR INLET	DIA.	4"	
CONTROL AMPS	24 VOLT	1.0	
FULL LOAD AMPS	115 VOLT	1.9	
MAX. OVER CURRENT PROTECTION	115 VOLT	15	
NORMAL POWER CONSUMPTION	WATTS	109	
DISCHARGE AIR TEMPERATURE RISE	Deg. F.	50	
AIR VOLUME	CFM	456	
DISCHARGE AIR OPENING AREA	ft ²	0.96	
OUTPUT VELOCITY	FPM	475	
FAN MOTOR	OPEN	0.02	
	ENCLOSED	0.06	
FAN MOTOR	RPM	1550	
FAN DIAMETER	INCHES	10	
SOUND LEVEL	d _{ba} @ 15 ft.	40	
DIMENSIONS			
HEIGHT	INCHES	13.3/4"	
LENGTH	INCHES	27"	
WIDTH	INCHES	29-3/4"	
APPROXIMATE NET WEIGHT	LBS.	58	
APPROXIMATE SHIP WEIGHT	LBS.	66	
CLEARANCES			
TOP	INCHES	1	
FLUE CONNECTOR	INCHES	6	
ACCESS PANEL	INCHES	18	
NON-ACCESS SIDE	INCHES	1	
BOTTOM	INCHES	1	
REAR	INCHES	18	
NOTES			
1	HEATING ONLY THERMOSTAT		
2			
3			

MANUFACTURER		REZTOR
MODEL NUMBER		UDZ 30
PERFORMANCE		
INPUT HEATING CAPACITY	BTUH	30,000
	kw/h	8.8
THERMAL EFFICIENCY	%	82%
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REAR	INCHES	18

NOTES	
1	HEATING ONLY THERMOSTAT
2	
3	

DEHUMIDIFICATION UNIT	
SYMBOL	DH-1
MANUFACTURER	DECTRON
INDOOR UNIT MODEL NUMBER	DH-1
OUTDOOR UNIT MODEL NUMBER	CU-1
	DS-010-NP-I-A3NH0601N0A2AN0H
	NC-B-1V-AUCSMO-V

DESIGN DATA	
OUTDOOR AIR (CFM)	100
ESP	0.5 INCHES
ROOM CONDITIONS (Deg. F DB / % RH)	82 / 50
UNIT TOTAL AIR FLOW (CFM)	600

ELECTRICAL DATA	
UNIT VOLTAGE (V/Ph/Hz)	208V / 1Ph / 60 Hz
UNIT FULL LOAD AMPS - FLA (A)	17
UNIT MCA (A) (MIN. CIRCUIT AMPACITY)	21
UNIT MOP (A) (MAX. OVERCURRENT PROTECT)	30

SUPPLY AIR BLOWER	
AIRFLOW (CFM)	600
TYPE	PLENUM
UNIT ESP (in WC)	0.5
NUMBER OF MOTORS	1
MOTOR HP	1.2
MOTOR FLA (A)	4.2
MOTOR DRIVE	DIRECT DRIVE

	COMPRESSOR
TYPE	SCROLL
NUMBER OF COMPRESSORS	1
REFRIGERANT	R410A
MOTOR RLA / LRA (A)	12.8 / 64.0

EVAPORATOR COIL	
SENSIBLE CAPACITY (MBH)	17.3
TOTAL CAPACITY (MBH)	26.1
MOISTURE REMOVAL CAPACITY (Lbs/h)	8.1
CIRCUITS	1
CONDENSATE DRAIN CONNECTION	1.0 Male NPT



REHEAT COIL	
TOAL HEAT REJECTION (MBH)	32.6
RTEMOTE OUTDOOR AIR-COOLED CONDENSER	

MODEL	NC-B-1V
DESIGN AIR ON TEMP (Deg. F.)	95 F

ESTIMATED FIELD CHARGE (lbs R410A)	TBD
RECOMMENDED LINE SET SIZE HG (in OD)	5/8
RECOMMENDED LINE SET SIZE LQ (in OD)	1/2
MAXIMUM LINE LENGTH (ft)	50
VOLTAGE (V/Ph/Hz)	208-230/1/30
NUMBER OF MOTORS	1
MOTOR HP	0.6
MOTOR FLA (A)	2.6
MCA (A)	4
MOP (A)	15

NOTES	
MODEL	2 TON COMPRESSOR DEHUMIDIFIER
UNIT SUBSERIES	NO POOL WATER HEATER
UNIT LOCATION	INDOOR
CABINET	COMPACT (SMALL)
SUPPLY VOLTAGE	208V / 1 PH
UNIT CONTROL	SUPERVISAIRE
REFRIGERANT	R410A
DISCONNECT	NO DISCONNECT
OUTDOOR AIR	OA INLET MOTORIZED DAMPER AND FILTER
EXHAUST FAN	NONE
SPACE HEATING	REMOTE HEATER BY OTHERS
HEAT CONTROL	STANDARD CONTROL SIGNALS: VALVE AND POWER SUPPLY BY OTHERS
AIR CONDITIONING	AIR COOLED A/C - FOR USE WITH REMOTE OUTDOOR AIR COOLED EQUIPMENT
OACC VOLTAGE	208V-230V/1PH
WARRANTY	STANDARD - 2 YR. ON DRIVELINE, COMPRESSOR, AND COILS
SUPPLY AIR (CFM)	600
OUTDOOR AIR (CFM)	100
SUPPLY AIR ORIENTATION	HORIZONTAL (SUPPLY END)
OUTDOOR AIR ORIENTATION	LEFT
CONDENSATE DRAIN	BOTTOM

[illegible]

	<div>DALE R. WILDE CO. CONSULTING ENGINEERS 428 WINCHESTER SUITE 240 SALT LAKE CITY, UTAH 84107 PHONE 801-433-1125 ~ EMAIL WILDE@DRWCO.COM</div>
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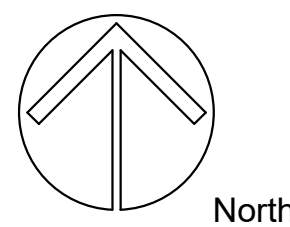
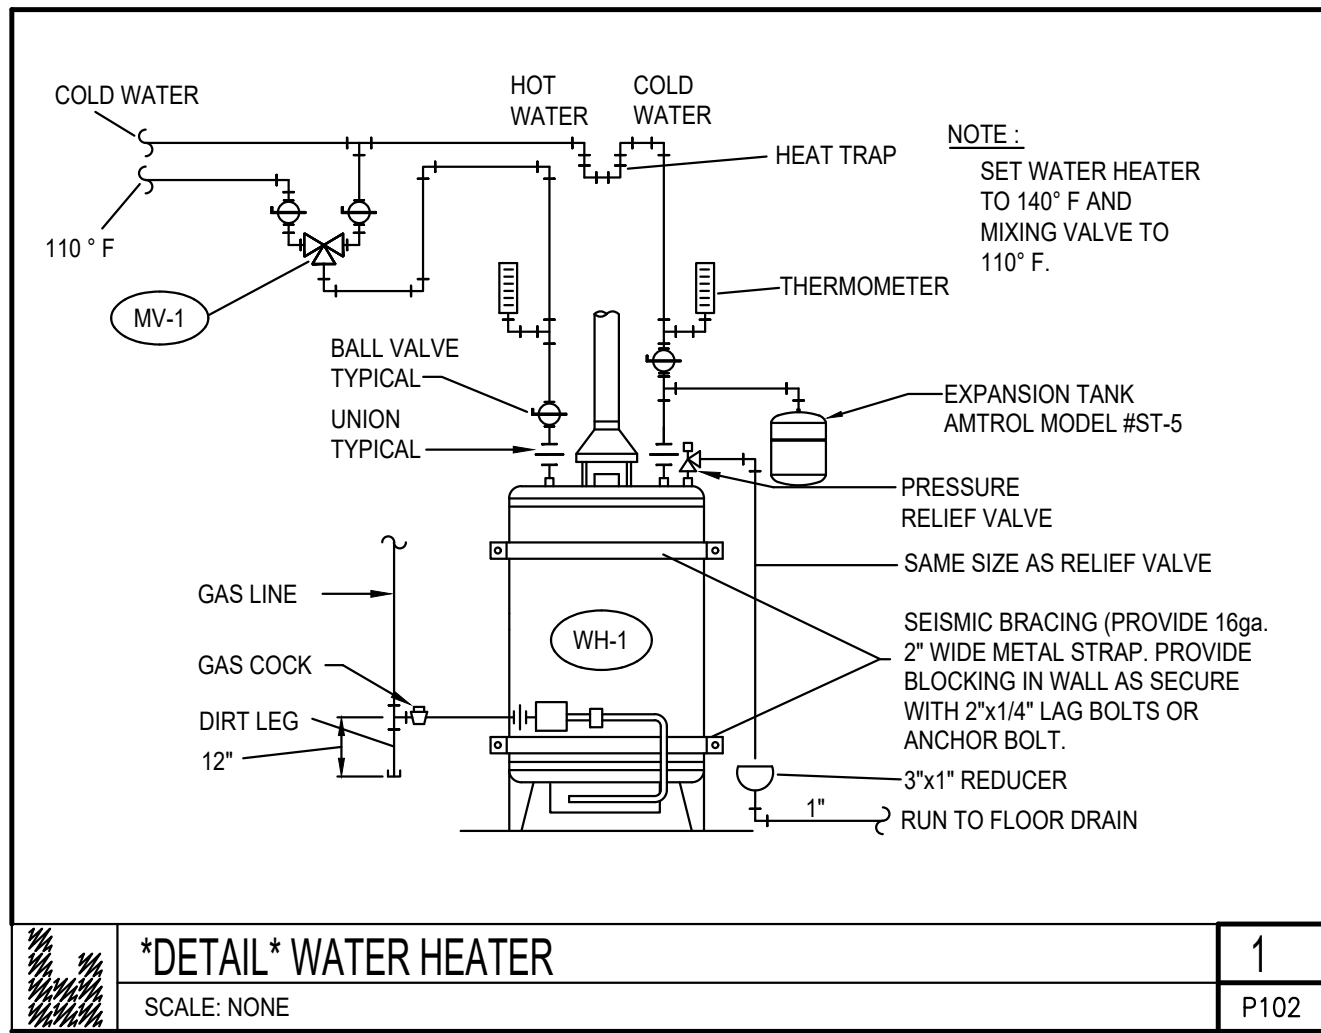
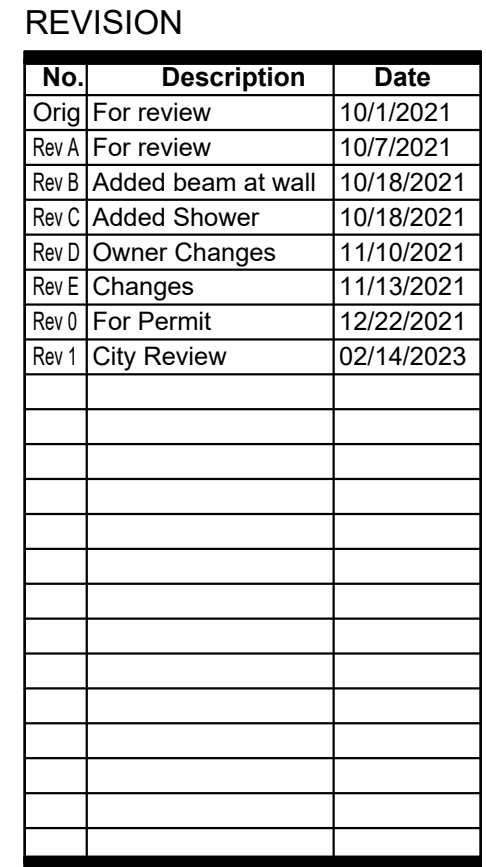
PROJECT and OWNER

ADAM ANDERSON
Garage and Exercise Spa Addition
33 East 100 North
American Fork, UT 84002

[illegible]

Project number	1417.175.02
Date Started	Feb. 15, 2023
Drawn by	DBH
Checked by	DRW

Scale As indicated



@DWGFULLNAMEEXT

PLUMBING FIXTURE SCHEDULE												
SYMBOL	FIXTURE	MANUFACTURER	MODEL NUMBER	WASTE	VENT	HOT WATER	COLD WATER					
FD-1	FLOOR DRAIN	JOSAM	30000-Z-S	2"	2"							
		J.R. SMITH	2005-A									
		MIFAB	F1100-C-1									
		WADE	W-1102-STD5-1									
		WATTS DRAINAGE	FD-100-A5									
	PRO-VENT SYSTEM TRAP GUARD	ZURN	Z-415									
		J.R. SMITH	2692									
		MIFAB	TG22IP 2"									
		SOILUX CHIEF	TG22SC									
NOTES:												
	1. CHOOSE ON MANUFACTURER FOR EACH CATEGORY.											
	2. 2" CAST IRON "P" TRAP.											
	3. 5" DIAMETER NICKEL BRONZE STRAINER.											
4. THE TRAP GUARD IS TO MEET ASSE 1072.												
HB-1	HOSE BIBB (INTERNAL)	WOODFORD	24				3/4"					
		CHICAGO FAUCET	387									
		MIFAB	HY9000									
		J.R. SMITH	560									
		T&S	B-0737									
		ZURN	Z1341									
	NOTES:											
		1. CHOOSE ONE MANUFACTURE FOR EACH CATEGORY.										
		2. FOR NON-FREEZING AREA.										
		3. EXTERNAL VACUUM BREAKER.										
4. ALL BRASS- POLISHED CHROME PLATED.												
5. LOOSE TEE KEY OPERATION HANDLE												
6. TAMPER PROOF LOCK SHIELD.												
L-1	LAVATORY COUNTERTOP	AMERICAN STANDARD	476 028	1-1/2"	1-1/2"	1/2"	1/2"					
		BRIGGS	6534									
		KOHLER	K-2196									
	FAUCET	AMERICAN STANDARD	7385 003									
		BRIGGS/SAYCO	S1503									
		CHICAGO	420-ABCP									
		DELTA	501-DST									
		KOHLER	K-15583-4RA-CP									
		SYMMONS	S-20-IFS									
		MOEN	L4621									
MIXING VALVE	ACORN CONTROLS	ST70-12										
	NIBCO	7105 ANGLE										
STOPS	NIBCO	7100 STRAIGHT										
	WATTS B&T	CHROME PLATED										
SUPPLY	BRASSCRAFT	CHROME PLATED										
	WATTS B&T	CHROME PLATED										
PROTECTIVE PIPE COVER	TRUEBRO	120-EZ										
	NOTES:											
1. CHOOSE ONE MANUFACTURER FOR EACH CATEGORY												
2. VITREOUS CHINA / SELF-RIMMING												
3. FAUCET HOLES AT 4" ON CENTER.												
4. FAUCET WITH FLOW RESTRICTOR AND AERATOR.												
5. PROVIDE A ASSE 1070 MIXING VALVE UNDER SINK WITH ACCESS DOOR.												
6. INTEGRAL PERFORATED GRID DRAIN.												
7. 17 GAUGE CHROME PLATED TUBE 1/2" TRAP.												
8. CHROME PLATED SUPPLY PIPES AND STOPS.												
MV-1	MIXING VALVE	LAWLER	570			110 DEG. F. 3/4" 140 DEF. F. 3/4"	3/4"					
NOTES:												
	1. CHOOSE ONE MANUFACTURE FOR EACH CATEGORY.											
	2. THERMOSTATIC MIXING VALVE, ASSE 1070 CERTIFIED CSA B125.3											
	3. COMBINATION STRAINER, CHECK AND STOPS.											
	4. SET TO MIX 140 DEG. F. WATER TO 110 DEG. F.											
5. SET AT 17 GPM AT 20 P.S.I. DIFFERENTIAL.												
SH-1	SHOWER FITTING	AMERICAN STANDARD	T675 501 & R120SS			1/2"	1/2"					
		KOHLER	K-TS6910-4A-CP									
		MOEN	8325									
		SYMMONS	9601-X-PLR									
NOTES:												
	1. CHOOSE ONE MANUFACTURER FOR EACH CATEGORY.											
	2. PRESSURE BALANCED.											
	3. 2-1/2 GPM SHOWER HEAD WITH FLOW RESTRICTOR.											
	4. BALL JOINT, ARM AND ESCUTCHEON.											
	5. SINGLE LEVEL HANDLE.											
	6. SERVICE STOPS AND VACUUM BREAKER.											
7. CHROME FINISH.												
WC-1	WATER CLOSET FLOOR TYPE TANK TYPE	AMERICAN STANDARD	215CA.104	4"	2"		1"					
		KOHLER	K-3531									
		TOTO	CS1744E									
	SEAT	AMERICAN STANDARD	5257.115 020									
		BEMIS	1100TT									
		BENEKE	520									
		CHURCH	380									
		COMFORT SEATS	C8019									
		NIBCO	7105 ANGLE									
		NIBCO	7100 STRAIGHT									
STOPS	BRASSCRAFT	CHROME PLATED										
	WATTS B&T	CHROME PLATED										
NOTES:												
	1. CHOOSE ONE MANUFACTURER FOR EACH CATEGORY.											
	2. 1.28 GALLONS PER FLUSH.											
	3. VITREOUS CHINA.											
	4. ELONGATED BOWL - TANK TYPE.											
	5. SEAT WITH U.L. STAINLESS STEEL HINGE POST AND CHECK.											
6. CHROME PLATED SUPPLY PIPE AND STOPS.												
WH-1	40 GALLON GAS FIRED WATER HEATER	BRADFORD WHITE	RG2PDV40T6N			3/4"	3/4"					
	EXPANSION TANK	AMTROL	ST-12									
		ELBI	XT-15									
		WATTS REGULATOR	DET-12									
	PRESSURE RELIEF VALVE	WATTS REGULATOR	40L									
NOTES:												
	1. CHOOSE ONE MANUFACTURER FOR EACH CATEGORY.											
	2. RECOVERY RATE OF 43 G.P.H. AT A 100 DEGREE F. TEMPERATURE RISE.											
	3. 40 GALLON GLASS LINED STORAGE TANK.											
	4. ENAMELED STEEL JACKET WITH HIGH DENSITY FIBERGLASS INSULATION.											
	5. 150 P.S.I. WORKING PRESSURE.											
	6. 40,000 BTU/H - NATURAL GAS - 2" PVC AIR INTAKE AND 2" PVC EXHAUST AIR.											
	7. DEDICATED 120 VOLT ELECTRICAL CIRCUIT FOR THE SPARK IGNITION.											
	8. ASME AND U.L. LISTED.											
	9. SET WATER TEMPERATURE AT 140 DEGREE F.											
	10. 5 YEAR WARRANTY.											
	11. WATER HEATER TO BE 80% EFFICIENCY MIN.											
12. SEE DETAIL ON DRAWING.												

PLUMBING GENERAL NOTES
CODES RULES AND REGULATIONS: ALL WORK SHALL CONFORM TO ALL APPLICABLE LOCAL AND STATE CODES. WHENEVER INDICATED MATERIAL WORKMANSHIP, ARRANGEMENT OR CONSTRUCTION IS OF HIGHER QUALITY OR CAPACITY THAN THAT REQUIRED BY THE ABOVE CODES, THE DRAWING AND OR SPECIFICATION SHALL GOVERN. SHOULD THERE BE ANY DIRECT CONFLICT BETWEEN THE STATE OR LOCAL CODES, LAWS OR REGULATION AND THE DRAWING AND OR SPECIFICATIONS THE CODES, LAWS OR REGULATIONS SHALL GOVERN. STANDARDS: INTERNATIONAL BUILDING CODE 2018 EDITION INTERNATIONAL PLUMBING CODE 2018 EDITION INTERNATIONAL MECHANICAL CODE 2018 EDITION INTERNATIONAL FUEL GAS CODE 2018 EDITION THE STATE OF UTAH "B" BOILER AND PRESSURE VESSEL REGULATIONS" EXAMINATION OF SITE: THE CONTRACTOR SHALL CAREFULLY EXAMINE THE DRAWINGS AND THE SITE AND FAMILIARIZE THEMSELVES WITH ALL EXISTING CONDITIONS BEFORE SUBMITTING ANY PROPOSAL. NO ADDITION COST WILL BE ALLOWED FOR FAILURE TO VISIT THE SITE. WORKING DRAWINGS AND MEASUREMENTS: THESE DRAWINGS ARE GENERALLY DIAGRAMMATIC. THEY DO NOT SHOW EVER OFFSET AND BEND THAT MAY BE NEEDED TO INSTALL THE WORK. THE CONTRACTOR SHALL COORDINATE THE DRAWINGS OF ALL OTHER TRADES INCLUDING BUT NOT LIMITED TO THE CIVIL, ARCHITECTURAL, ELECTRICAL, AND STRUCTURAL. THESE DRAWINGS SHALL NOT BE SCALED FOR ROUGH IN OR AS SHOP DRAWINGS. EQUIPMENT SUBMITTALS: PROVIDE ALL AT ONE TIME IN A THREE RING BINDER SIX COPIES OF EQUIPMENT PROPOSED TO BE USED ON THIS PROJECT. REGARDLESS OF ANY INFORMATION OUTLINED IN THE SUBMITTALS OR SHOP DRAWINGS, THE REQUIREMENTS OF THE DRAWINGS MUST FOLLOWED AND AR NOT WAIVED OR SUPERSEDED IN ANY WAY BY THE SUBMITTALS OR SHOP DRAWING REVIEW. CAULKING AND SEALING: ALL SPACES BETWEEN PIPES AND SLEEVES THROUGH FIRE WALLS, FIRE PARTITIONS, FLOORS, AND CEILINGS SHALL CAULKED WITH ONE INCH FILL OF 3M "FIRE BARRIER". CAULKING MUST BE ON BOTH SIDES OF FIRE RATED WALLS. SUPERVISION AND WORKMANSHIP: PROVIDE THE SERVICES OF AN EXPERIENCED FORMAN WHO SHALL BE IN CHARGE OF ALL INSTALLATION. ALL WORKMANSHIP SHALL BE OF FIRST QUALITY. NONE BUT COMPETENT MECHANICS SHALL BE EMPLOYED IN THE WORK. SHODDY WORKMANSHIP WILL BE CAUSE FOR REJECTION AND REPLACEMENT OF WORK WITHOUT ADDITIONAL COST. COOPERATION WITH OTHER TRADES: REFER TO ALL THE DRAWINGS COVERING WORK OF ALL TRADES, WHICH IS CARRIED ON IN CONJUNCTION WITH THE WORK SUCH THAT ALL WORK CAN PROCEED WITHOUT INTERFERENCE RESULTING FROM LACK OF COORDINATION. MANUFACTURERS INSTRUCTIONS: THE CONTRACTOR SHALL FOLLOW THE MANUFACTURERS INSTALLATION INSTRUCTION EXPLICITLY IN THE INSTALLATION OF ALL ITEMS OF EQUIPMENT. COMPLETION REQUIREMENTS: ALL SYSTEMS SHALL BE TESTED BY THE CONTRACTOR TO DEMONSTRATE THE ALL EQUIPMENT FURNISHED AND INSTALLED OR CONNECTED FUNCTION IN THE MANNER REQUIRED. ADJUSTMENTS, OPERATION, ETC. ADJUST ALL REGULATORS, FAUCETS, ETC. OPEN AND CLOSE ALL VALVES SEVERAL TIMES TO INSURE SEAL. CLEANING: THIS CONTRACTOR SHALL CLEAN ALL EXPOSED PIPING, INSULATED MEMBERS, FIXTURES AND EQUIPMENT INSTALLED AND LEAVE READY FOR PAINTING. REFINISH AND DAMAGED FINISH AND LEAVE IN PROPER WORKING ORDER. GUARANTEE: BY THE ACCEPTANCE OF AN CONTRACT AWARD FOR THE WORK HEREIN DESCRIBED OR SHOWN ON THE DRAWINGS, THE CONTRACTOR ASSUMES THE FULL RESPONSIBILITY IMPOSED BY THE GUARANTEE AS SET FORTH HEREIN, AND SHALL PROTECT HIMSELF THROUGH PROPER GUARANTEES FROM EQUIPMENT VENDORS AND FROM SUBCONTRACTORS AS THEIR INTERESTS MAY APPEAR. 1. THAT THE ENTIRE PLUMBING SYSTEMS SHALL BE QUIET IN OPERATION. 2. THAT THE CIRCULATION OF WATER SHALL BE COMPLETE AND EVEN INCLUDING THE DOMESTIC HOT WATER SYSTEM. 3. THAT HE WILL MAKE PROMPTLY UPON NOTICE, FREE OF CHARGE, ANY REPAIRS NECESSARY DUE TO DEFECTIVE MATERIALS OR MATERIALS OR WORKMANSHIP THAT MAY OCCUR DURING A PERIOD OF ONE YEAR FROM THE DATE OF SUBSTANTIAL COMPLETION. THE EXISTING UTILITY CONNECTIONS HAVE BEEN DETERMINED BASED ON THE INFORMATION AVAILABLE. NO DESTRUCTIVE DEMOLITION HAS BEEN PERFORMED TO CONFIRM THE EXISTENCE AND OR LOCATION OF THE EXISTING CONDITIONS. THE CONTRACTOR IS RESPONSIBLE FOR VERIFYING THE EXISTING CONDITIONS PRIOR TO START OF WORK. ANY DIVINATION FROM THE CONDITIONS SHOWN ON THE DRAWINGS SHALL BE BROUGHT TO THE ATTENTION OF THE ARCHITECT FOR EVALUATION AND DIRECTION. THE COST OF REMEDIAL WORK DUE TO FAILURE OF THE CONTRACTOR TO VERIFY THE EXISTING CONDITIONS PRIOR TO THE START OF WORK WILL BE BOURNE BY THE CONTRACTOR.

PLUMBING PIPING SCHEDULE
NOTES: GRADE ALL DOMESTIC WATER PIPING TO DRAIN. PROVIDE DRAIN AT ALL LOW POINTS WITH HOSE CONNECTION AND CAP. GRADE ALL WASTE AND VENT PIPING TO CONFORM TO THE INTERNATIONAL PLUMBING CODE. ALL PIPING SHALL BE SUPPORTED WITH CLEVIS HANGERS ON THE FOLLOWING SPACING: STEEL PIPE 1" AND SMALLER 5 FEET STEEL PIPE 1-1/4" AND LARGER 10 FEET COPPER TUBING 1-1/4" AND SMALLER 5 FEET COPPER TUBING 1-1/2" AND LARGER 10 FEET PLASTIC PIPE 3 FEET CAST IRON SOIL PIPE - SUPPORT AT EACH JOINT AND AT INTERVALS NOT TO EXCEED 5 FEET. HANGER ROD SIZING AS FOLLOWS: PIPE SIZE ROD SIZE 1/2" TO 2" 3/8" 2-1/2" TO 3" 1/2" 4" AND LARGER 5/8" PROVIDE INSULATION PROTECTION SHIELDS AT ALL HANGERS. PROVIDE ISOLATION VALVES AND UNIONS AT ALL EQUIPMENT. PROVIDE DIELECTRIC UNIONS BETWEEN DISSIMILAR PIPE MATERIALS. BACK FILL AND COMPACT ALL TRENCHING TO PREVENT SETTLEMENT AND TO PROPERLY SUPPORT BELOW GRADE PIPING. PLASTIC PIPING IN AIR PLENUMS IS PROHIBITED. ALL MATERIAL LOCATED IN AIR PLENUMS MUST HAVE SURFACE BURNING CHARACTERISTICS NOT EXCEEDING FLAME SPREAD 25 AND SMOKE GENERATED 50. SYMBOL DESCRIPTION HW DOMESTIC HOT WATER PIPING CW DOMESTIC COLD WATER PIPING HWR DOMESTIC HOT WATER RECIRCULATING PIPING COPPER TUBE BELOW GRADE: TYPE K HARD DRAWN COPPER CONFORMING TO ANSI H23.1 COPPER TUBE ABOVE GRADE: TYPE L HARD DRAWN COPPER CONFORMING TO ANSI H23.1 COPPER TUBE FITTINGS: 2-1/2" AND SMALLER: WROUGHT COPPER, SOLDER JOINT PRESSURE FITTINGS CONFORMING TO ASME B16.22 SOLDER WITH NON LEAD SOLDER IN ACCORDANCE WITH THE REQUIREMENTS OF THE COPPER DEVELOPMENT ASSOCIATION'S "THE COPPER TUBE HANDBOOK" INCLUDING REAMING AND DE-BURRING. 3" AND LARGER: WROUGHT COPPER AND BRONZE GROOVED END FITTINGS CONFORMING TO ASTM B75 TUBE AND ASTM B584 BRONZE CASTINGS. COUPLING FOR GROOVED END COPPER TUBE AND GROOVED END COPPER FITTINGS CONSISTING OF ASTM A 536 DUCTILE IRON OR ASTM A 47 MALLEABLE IRON HOUSING HAVING COPPER COLORED ENAMEL FINISH WITH SYNTHETIC RUBBER GASKET HAVING CENTRAL CAVITY PRESSURE RESPONSIVE DESIGN AND SUITABLE FOR SERVICE. WASTE PIPING GREASE WASTE PIPING VENT PIPING PLASTIC PIPE: POLY (VINYL CHLORIDE) (PVC) ASTM D 2665 SOLID CORE SCHEDULE 40 PLAIN ENDS ACRYLONITRILE BUTADIENE STYRENE (ABS) ASTM D 2661 SOLID CORE SCHEDULE 40 PLAIN ENDS CAST IRON: SERVICE WEIGHT CAST IRON COATED HUB LESS SOIL PIPE CONFORMING TO THE REQUIREMENTS OF CISPI STANDARD 301, ASTM A888 OR ASTM A74. PIPE FITTINGS: PVC: DWV PIPE FITTINGS CONFORMING TO ASTM D 2665 MADE TO ASTM D3311 SOCKET-TYPE DRAIN WASTE AND VENT PIPE PATTERNS. SOLVENT CEMENTS: ASTM D 2564 AND ASTM F 656 PRIMER PVC TO ABS TRANSITION ASTM D 3136 COLOR OTHER THAN ORANGE ABS: DWV PIPE FITTINGS CONFORMING TO ASTM D 2661 SOLID CORE MADE TO ASTM D 3311 SOCKET-TYPE DRAIN WASTE AND VENT PIPE PATTERNS SOLVENT CEMENT: ASTM D 2235 CAST IRON: HUBLESS CAST IRON CONFORMING TO CISPI 310 HAVING ASTM C 564 NEOPRENE SEALING SLEEVE WITH 300 SERIES STAINLESS STEEL CORRUGATED SHIELD AND CLAMP ASSEMBLY. G NATURAL GAS PIPING STEEL PIPE: 4" AND SMALLER, SCHEDULE 40 OR SCHEDULE 80 BLACK CONFORMING TO ASTM-A53 GRADE A. SIZE 5" AND LARGER, SCHEDULE 40 OR SCHEDULE 80 BLACK CONFORMING TO ASTM-A53 GRADE F. STEEL PIPE FITTINGS: 2" AND SMALLER, MALLEABLE THREADED FITTINGS, ANSI B16.3, CLASS 150 STANDARD PATTERN FOR THREADED FITTINGS. THREADS SHALL CONFORM TO ANSI B1.20.1. 2-1/2" AND LARGER, SCHEDULE 40 WROUGHT STEEL WELDING FITTINGS CONFORMING TO ANSI B16.28.

PLUMBING PIPING SCHEDULE
SYMBOL DESCRIPTION D CONDENSATE DRAIN DOMESTIC TYPE L HARD DRAWN COPPER CONFORMING TO ANSI H23.1 COPPER TUBE FITTINGS: 2-1/2" AND SMALLER: WROUGHT COPPER, SOLDER JOINT PRESSURE FITTINGS CONFORMING TO ASME B16.22 SOLDER WITH NON LEAD SOLDER IN ACCORDANCE WITH THE REQUIREMENTS OF THE COPPER DEVELOPMENT ASSOCIATION'S "THE COPPER TUBE HANDBOOK" INCLUDING REAMING AND DE-BURRING. NOTES: ALL INSULATION SHALL HAVE SURFACE BURNING CHARACTERISTICS, AS TESTED BY ASTM E84, UL723 OR NFPA 255 NOT EXCEEDING : FLAME SPREAD 25 AND SMOKE DEVELOPED 50. COMPOSITE SHALL INCLUDE INSULATION JACKETING AND ADHESIVES USED TO SECURE JACKETING OR FACING. ALL ACCESSORY ITEMS SUCH AS PVC JACKETING AND FITTINGS, ADHESIVES, MASTIC, CEMENT, TAPE AND CLOTH SHALL HAVE SAME COMPONENT RATINGS AS ABOVE. PIPE INSULATION: FIBERGLASS SECTIONAL PIPE INSULATION: THERMAL CONDUCTIVITY OF 0.23 BUT-IN PER SQ FT PER HOUR AT 75 DEG F MEAN TEMPERATURE. MINIMUM DENSITY OF 2 LBS PER CUBIC FOOT. JACKETED WITH WHITE VAPOR BARRIER LAMINATED OF ALUMINUM FOIL AND WHITE KRAFT REINFORCED WITH GLASS FIBER STRANDS. JACKET SHALL HAVE FACTOR APPLIED SELF-SEALING LAP. PLASTIC INSULATION FITTING COVERS: FACTORY FABRICATED FINNTING COVERS MANUFACTURED FROM 30-MIL THICK, HIGH-IMPACT ULTRAVIOLET RESISTANT PVC. PIPE INSULATION INSTALLATION: INSTALLATION SHALL BE CONTINUOUS THROUGH WALLS, FLOORS, PARTITIONS, SLEEVES AND PIPE HANGERS. APPLY INSULATION TO PIPE AND SEAL WITH SELF-SEALING LAP. USE SELF-SEALING BUTT STRIPS TO SEAL BUTT JOINTS. INSULATION NOT REQUIRED OVER UNION, AND VALVE BODIES ON DOMESTIC HOT WATER. INSTALL PLASTIC FITTING COVERS IN ACCORDANCE WITH MANUFACTURERS INSTALLATION INSTRUCTIONS. INSULATION INSTALLED OUTSIDE SHOULD BE COVERED WITH ALUMINUM JACKET. PIPE INSULATION THICKNESS: INSULATION RUN THICKNESS RUN OUTS TO 2" 1" AND LESS 1-1/4" TO 2" 2-2" TO 4" 5" TO 6" DOMESTIC HOT WATER 1/2" 1" 1" 1-1/2" 1-1/2" DOMESTIC HOT WATER 1/2" 1" 1" 1-1/2" 1-1/2" RECIRCULATING DOMESTIC COLD WATER 1/2" 1/2" 1/2" 1/2" 1/2" ROOF DRAINS 1/2" 1/2" 1/2" 1/2" 1/2"

GENERAL NOTES
COORDINATE ALL SUSPENDED EQUIPMENT WITH ARCHITECTURAL REFLECTED CEILING PLAN. IT IS THE RESPONSIBILITY OF THE PLUMBING CONTRACTOR TO COORDINATE HIS WORK WITH ALL OTHER TRADES. COORDINATE ALL ROOF PENETRATIONS WITH STRUCTURAL DRAWINGS. ALL FIXTURES ARE DESIGNED TO BE FIXED IN POSITION SHALL BE SECURELY FASTENED IN PLACE. ALL QUESTION MUST BE SUBMITTED TO THE ARCHITECT IN THE FORM OF AN RFI. ANY RFI SENT DIRECTLY TO ENGINEER WILL BE RETURNED UNREAD. ANY RFIs THAT HAVE BEEN CORRECTED OR APPROVED BY THE ENGINEER WILL BE JUST FOR CLARIFICATION, AND DOES NOT CONSTITUTE A CHANGE ORDER. CHANGE ORDERS MUST BE SUBMITTED TO THE ARCHITECT. THE CHANGE ORDER SHALL BE COMPLETE BY LISTING THE FINAL PRICING WITH PROPER BREAKDOWN AND DOCUMENTATION. POSSIBLE TIME EXTENSION OR DELAY AND THE ASSOCIATED COST FOR THE TIME EXTENSION OR DELAY. MATERIAL AND LABOR COST. RFIs WITH BE RETURNED TO ARCHITECT FROM ENGINEER WITHIN 5 WORKING DAYS. CHANGE ORDERS WILL BE RETURNED TO ARCHITECT FROM ENGINEER WITHIN 15 DAYS. DO NOT PROCEED WITH RFI UNTIL CHANGE ORDER HAS BEEN APPROVED BY ARCHITECT, OWNER AND ENGINEER. IF CONTRACTOR DOES SO IT WILL BE AT THERE OWN RISK. IF TIME EXTENSIONS AND/OR DELAYS ARE INCURRED DUE TO FAILURE TO ISSUE AN RFI, CHANGE REQUEST, CHANGE ORDER, OR IMPROPER AND/OR INCOMPLETE DOCUMENTATION THE COST ASSOCIATED WITH THE DELAY WILL BE BORNE BY THE CONTRACTOR.









ADAM ANDERSON
Garage and Exercise Spa Addition
33 East 100 North
American Fork, UT 84002




REVISION		
No.	Description	Date
Orig	For review	10/1/2021
Rev A	For review	1

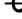


1. FURNISH LABOR AND MATERIALS FOR A COMPLETE JOB.
2. ALL WORK, MATERIALS, EQUIPMENT AND LABOR SHALL COMPLY IN ALL RESPECTS WITH THE REQUIREMENTS OF ALL FEDERAL, COUNTY, CITY AND STATE OF UTAH APPLICABLE ORDINANCES, REGULATIONS AND CODES, INCLUDING REGULATIONS OF SERVING UTILITIES. IN ADDITION THE FOLLOWING PUBLISHED STANDARDS SHALL BE ADHERED TO:
SMACNA DUCT CONSTRUCTION STANDARDS
3. SECURE ALL PERMITS, LICENSES, FEES AND SERVICE CHARGES.
4. ALL WIRING SHALL BE DONE ACCORDING TO ALL GOVERNING CODES.
5. FITTINGS SHALL MEET ALL GOVERNING CODES.
6. CONDUCTORS - COPPER NO. 12 OR LARGER.
7. CONNECTORS - STEEL SPRING WIRE CONNECTORS OR PRESSURE TYPE TERMINAL LUGS.
8. SWITCHES AND RECEPTACLES ARE 20 AMPERE SPEC, GRADE AND SWITCHES ARE SINGLE POLE WHERE NOT INDICATED OTHERWISE.
9. OUTLET BOXES AND JUNCTION BOXES SHALL BE OF GALVANIZED STEEL OF CORRECT SIZE AND SHAPE.
10. CIRCUIT BREAKERS SHALL BE BOLT-ON TYPE AND ALL FUSES SHALL BE TIME DELAY SIZED FOR LOAD SERVED.
11. ALL FIXTURES SHALL BE FASTENED SECURELY IN PLACE WITH SEISMIC TIES AS PER CODE.
12. FINAL CONNECTIONS TO ALL EQUIPMENT SHALL BE PER MANUFACTURE'S APPROVED WIRING DIAGRAMS, DETAILS AND INSTRUCTIONS. IT SHALL BE THE ELECTRICAL CONTRACTOR'S RESPONSIBILITY TO PROVIDE MATERIALS AND EQUIPMENT COMPATIBLE WITH EQUIPMENT ACTUALLY SUPPLIED.
13. FINAL CONNECTIONS TO ALL MOTORS, AND OTHER VIBRATION EQUIPMENT SHALL BE WITH SEAL TITE FLEX AND APPROVED FITTINGS.
14. ALL PLUG RECEPTACLES IN AREAS WITH CONCRETE FLOORS SHALL BE GFCI PROTECTED.

WP	Weatherproof
	Light switch
	LED Dimmer
	Switch with Pilot Light
	Occupancy Sensor Duel Tech.
	120 V convenience outlet
GFCI	Ground Fault Interruptor
	Exhaust fan (furnished and installed by Mechanical Contractor)
	Motor connection
	Motor Disconnect Switch

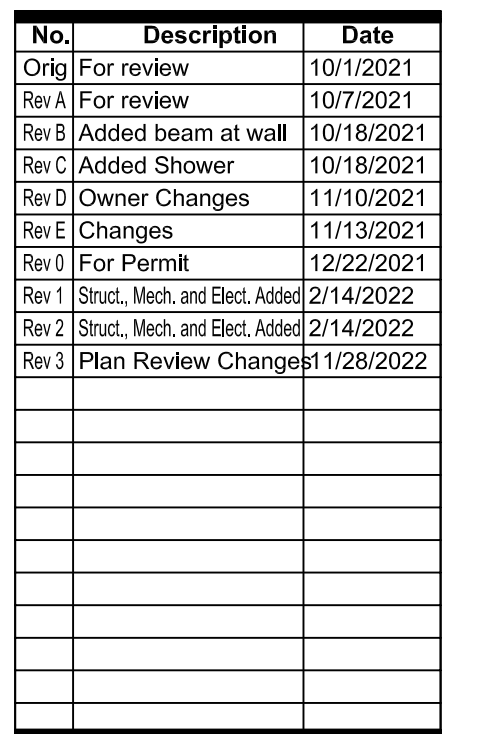

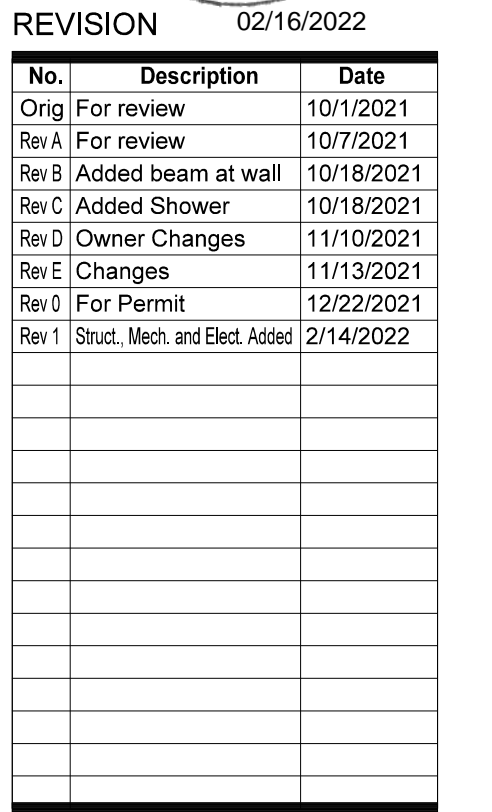

Project number	1417.175.02
Date Started	29 Sep 2021
Drawn by	JDR
Checked by	NHR



Project number	1417.175.02
Date Started	29 Sep 2021
Drawn by	JDR
Checked by	NHR







FEEDER  TOP
 BOTTOM

LOAD TOTAL: 49,500
FLA 206

[illegible]FOUNDATION PLAN

scale As indicated

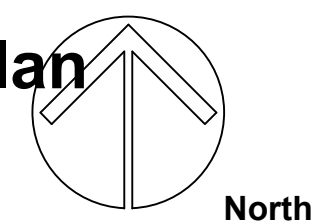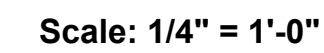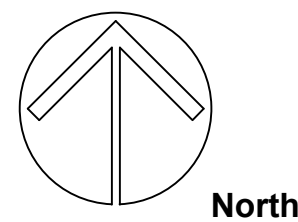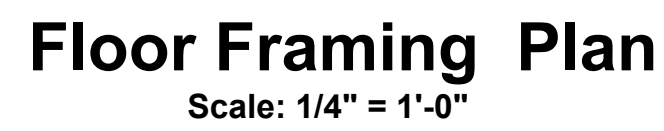

1. PLACE REBAR 3" CLEAR FROM BOTTOM.
2. F ----- S INDICATES STEP IN FOOTING

1. ALL FOOTINGS ARE BASED ON AN ALLOWABLE SOIL BEARING PRESSURE OF 1500 PSF. ANY SOIL CONDITION ENCOUNTERED DURING EXCAVATION THAT IS CONTRARY TO THOSE USED FOR DESIGN OF FOOTINGS AS OUTLINED IN WORKING DRAWINGS SHALL BE BROUGHT TO THE ATTENTION OF THE ARCHITECT/ENGINEER BEFORE PROCEEDING.
2. ALL FOOTINGS SHALL BEAR ON NATURAL UNDISTURBED SOIL OR ON ENGINEERED GRANULAR FILL COMPACTED TO 95% OF MAX DENSITY, BASED ON ASTM D1557 METHOD OF COMPACTION. FILL SHALL BE PLACED IN LAYERS NOT TO EXCEED EIGHT INCHES IN DEPTH AFTER COMPACTION AND SHALL EXTEND DOWN TO IN-SITU COHESIVE SOILS. FILL SHALL BE COMPACTED UNDER ALL CONCRETE WORK ON THE SITE.
3. NO FOOTINGS SHALL BE PLACED IN WATER OR ON FROZEN GROUND.
4. ALL EXCAVATIONS ADJACENT TO AND BELOW FOOTING ELEVATIONS FOR OTHER TRADES SHALL BE ACCOMPLISHED PRIOR TO POURING ANY FOOTINGS.
5. CONTRACTOR SHALL BE RESPONSIBLE FOR LATERALLY SUPPORTING ALL RETAINING TYPE FOUNDATION WALLS WHILE COMPACTING BEHIND WALLS AND UNTIL ALL SUPPORTING MEMBERS HAVE BEEN PLACED (SUCH AS FLOOR SLABS). ALL OPEN EXCAVATIONS AND TRENCHES SHALL BE SUPPORTED AND BARRICADED BY CONTRACTOR TO CONFORM WITH OSHA SAFETY STANDARDS.
6. ALL REINFORCEMENT SHALL BE SECURELY TIED IN PLACE PRIOR TO POURING CONCRETE.
7. ALL SLABS ON GRADE SHALL BE OVER 4" OF 3/4" FREE-DRAINING GRANULAR FILL. TYPICAL SLABS SHALL BE REINFORCED WITH #4 BARS AT 18" o.c. SEE PLANS AND DETAILS FOR SPECIAL REINFORCING ETC.

ADAM ANDERSON

Garage and Exercise Spa Addition

33 East 100 North

American Fork, UY 84002



2-17-2023

REVISION

No.	Description	Date
Orig	For review	10/1/2021
Rev A	For review	10/7/2021
Rev B	Added beam at wall	10/18/2021
Rev C	Added Shower	10/18/2021
Rev D	Owner Changes	11/10/2021
Rev E	Changes	11/13/2021
Rev D	For Permit	12/22/2021
Rev F	For Permit	2/15/2023


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Project number	2203
Date Started	4 Feb 2022
Drawn by	DGH
Checked by	DGH

ROOF FRAMING PLAN

S1.1

Scale	As indicated
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BEAM #	SIZE	TYPE	COLUMN
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COLUMN SCHEDULE

COL #	SIZE	TYPE
C-1	(2) 2X6 TRIMMERS AND (1) 2X6 KING STUD	DOUG FIR
C-2	6X6 POST (PLUS 2-KING STUDS IN WALLS)	DOUG FIR

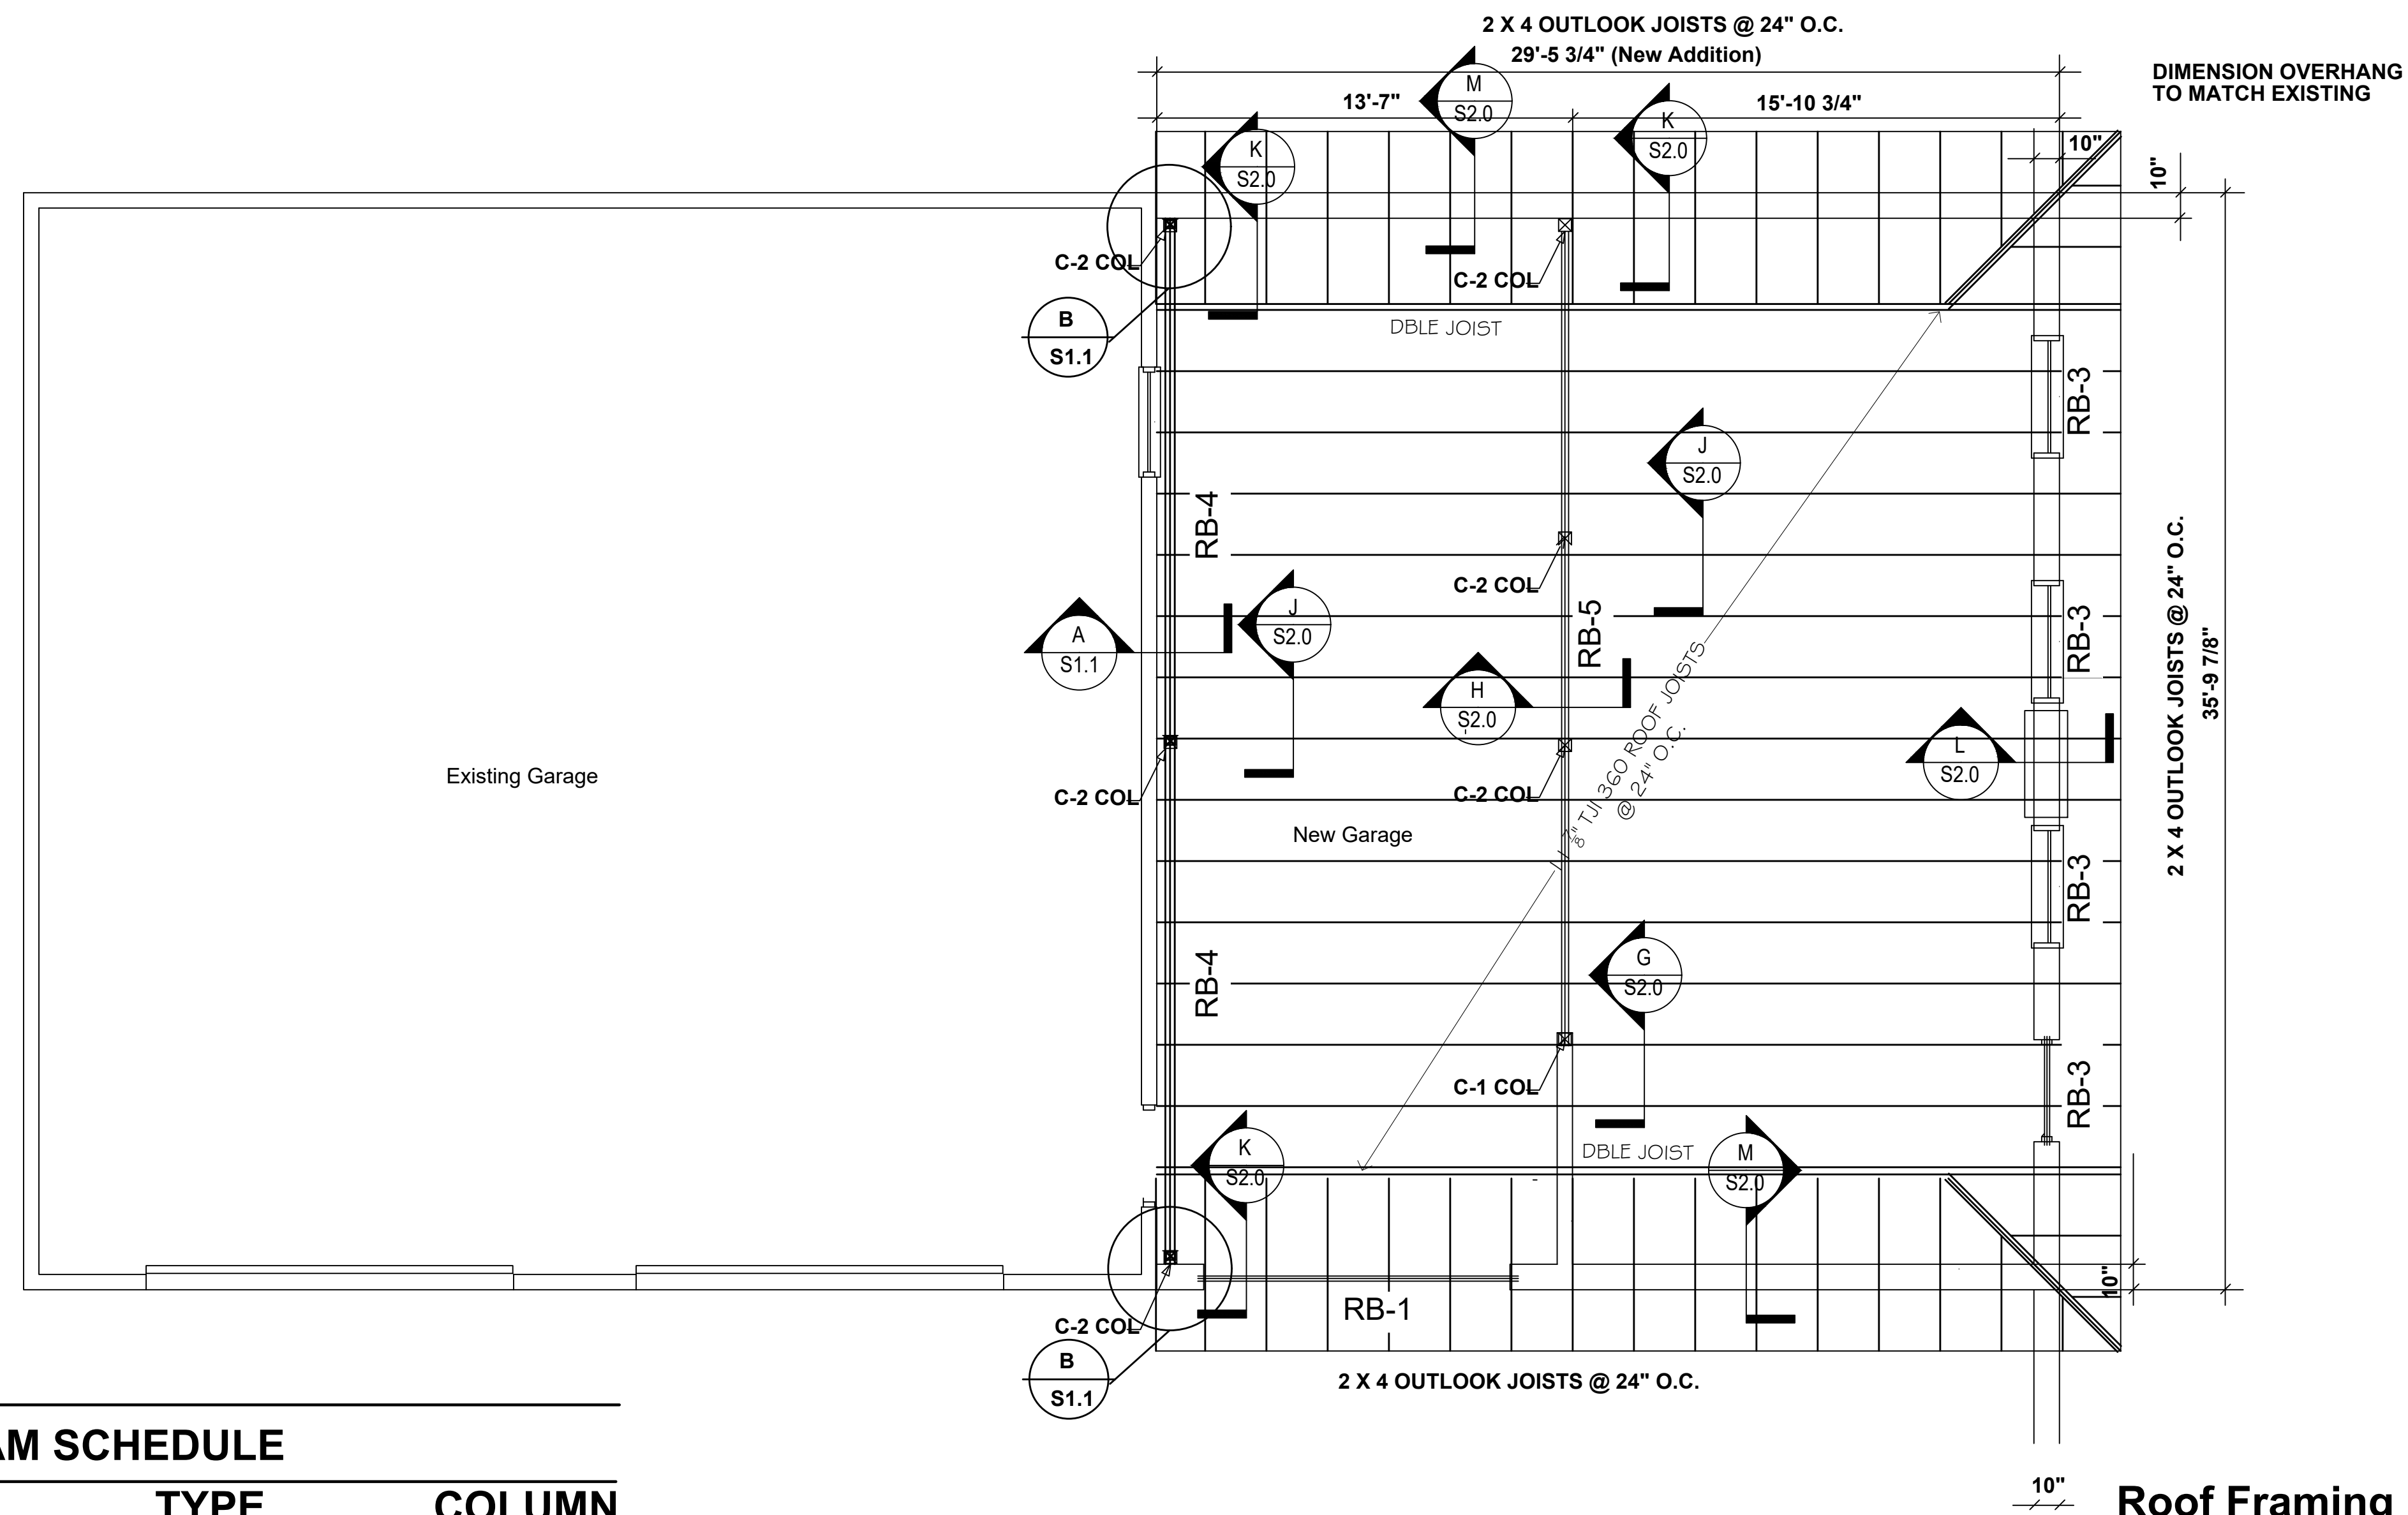

CONNECTION C-2 COL. TO WALL



CONNECTION OF JOISTS TO EXISTING WALL FOR LATERAL FORCE TRANSFER



Scale As indicated

**AMERICAN FORK CITY
PLANNING COMMISSION STAFF REPORT**

MEETING DATE: March 22, 2023

AGENDA TOPIC:

Review and action on a Site Plan application for the Children's Justice Center Project, located at 96 S 100 E, in the Central Commercial (CC-1) Zone.

BACKGROUND INFORMATION		
Location:		96 South 100 East
Project Type:		Site Plan
Applicants:		Utah County Children's Justice Center, Legend Engineering
Existing Land Use:		General Commercial
Proposed Land Use:		N/A
Surrounding Land Use:	North	General Commercial
	South	Residential High Density
	East	Residential High Density
	West	Residential High Density
Existing Zoning:		CC-1
Proposed Zoning:		N/A
Surrounding Zoning:	North	CC-1
	South	R4-7500
	East	R4-7500
	West	R4-7500

BACKGROUND:

The applicant is applying for Site Plan Approval for the Children's Justice Center, for the development of a justice center for children facing abuse, located at 96 South 100 East. The proposal consists of 1 parcel for a governmental structure and the entire development parcel consists of approximately 0.2 acres. The current site has been approved by City Council to have 6 parking stalls, but no Site Plan has been approved just yet. The Children's Justice Center Project has been brought back to Planning Commission because the previous Site Plan that was approved had seven parking stalls, now they are providing 6. Due to this Site Plan adjustment, it has been brought back to Planning Commission and will need a recommendation to their parking stalls for their final step of the Site Plan.

Sec 17.6.101 Administrative Site Plan Review

Wherever the terms of this code require submission and approval of a site plan, such review shall be conducted in accordance with the following provisions.

1. Planning commission to approve. The planning commission, acting in an administrative capacity, shall have the function, duty and power to approve or disapprove a project plan and to attach such modifications or conditions as may be deemed appropriate to improve the layout, to ensure that the project will not pose any detrimental effect to persons or property, or to protect the health, safety, and general welfare of the citizens of the city.
2. Application required. Application for site plan approval shall be submitted on forms provided by the city and shall be accompanied by maps and drawings showing the following:
 1. The location of all existing and proposed buildings and structures on the site, with full dimensions showing the distance between buildings and distances from buildings to adjacent property lines.
 2. The location of all parking spaces, driveways, and points of vehicular ingress and egress.
 3. A landscaping plan showing the location, types, and initial sizes of all planting materials to be used together with the location of fences, walls, hedges, and decorative materials.
 4. Preliminary elevations of main buildings showing the general appearance and types of external materials to be used.
 5. The locations of solid waste receptacles and trash pick-up areas.
3. Appeals permitted. Any person aggrieved by a determination of the planning commission may request a hearing before the city council who shall have the authority to reverse, affirm or modify any decision of said commission. Any such appeal shall be filed within ten days of the determination of the planning commission.
4. Issuance of a permit. A building permit shall not be issued for any building or structure or external alterations thereto until the provisions of this section have been complied with. Any construction not in conformance with an approved site plan shall be considered a violation of this code. Any building permit issued shall ensure that development is undertaken and completed in conformity with the plans as approved.

PROJECT MAP:



FINDINGS OF FACT:

- Reduction of parking can be requested and recommended by Planning Commission. This is mentioned in Section 17.5.133 (D) of American Fork City Municipal Code.
- City Council has approved this site to have 6 parking stalls, but still needs to be recommended by Planning Commission
- Planning Commission will be the approval body of this Site Plan as it resides in the CC-1 zone. This is mentioned in Section 17.4.401 (D) of American Fork City Municipal Code.

STANDARD CONDITIONS OF APPROVAL:

APPLICANT is responsible and shall submit/post/obtain all necessary documentation and evidence to comply with these Standard Conditions of Approval prior to any platting, permitting, or any other form of authorization by the City including plat recording or other property conveyance to the City and prior to scheduling a pre-construction meeting. All recording shall take place at the Utah County Recorder's Office.

1. **Title Report:** Submit an updated Title Report not older than 30 days or other type of appropriate verification that shows all dedications to the City are free and clear of encumbrances, taxes, or other assessments.
2. **Property Taxes and Liens:** Submit evidence that all the property taxes, for the current and/or previous years, liens, and agricultural land use roll over fees have been paid in full.
3. **Water Rights:** Submit evidence that all the required water rights have been conveyed to American Fork City.
4. **Performance Guarantee:** Post a performance guarantee for all required public and essential common improvements.
5. **Easements and Agreements:** Submit/record a long-term Storm Water Pollution Prevention Maintenance Agreement signed and dated by the property owner and any required easement documentation.
6. **Land Disturbance Permit:** Obtain a Land Disturbance Permit.
7. **Compliance with the Plan Review Comments:** All plans and documents shall comply with all the Technical Review Committee comments and the City Engineer's final review.
8. **Commercial Structure:** Record an Owner Acknowledgment and Utility Liability Indemnification if the proposed building is a multi-unit commercial structure served by a single utility service.
9. **Sensitive Lands:** Record all applicable documents required for compliance with the City's Sensitive Lands Ordinance.
10. **Utility Notification Form:** Submit a Subdivision Utility Notification Form.
11. **Professional Verification:** Submit final stamped construction documentation by all appropriate professionals.
12. **Fees:** Payment of all development, inspection, recording, streetlight, and other project related fees.
13. **Mylar:** Submit a Mylar. All plats will receive final verification of all formats, notes, conveyances, and other items contained on the plat by City staff (recorder, legal, engineer, GIS, planning).

POTENTIAL MOTIONS – Site Plan

APPROVAL

Madame Chairwoman, I move that we approve the site plan and recommend the reduction of parking stalls to _____ stalls, for the redevelopment of a property for use as the Children's Justice Center, located at 96 South 100 East, in the CC-1 zone, subject to any conditions found in the Staff Report and recommended by the Fire Marshall.

DENIAL


Madame Chairwoman, I move that we deny the site plan and parking reduction request for the redevelopment of a property for use as the Children's Justice Center, located at 96 South 100 East, in the CC-1 zone.

TABLE

Madame Chairwoman, I move that we table action on the site plan and parking reduction request for the redevelopment of a property for use as the Children's Justice Center, located at 96 South 100 East, in the CC-1 zone, and instruct the developer/staff to

UTAH COUNTY CHILDREN'S JUSTICE CENTER
96 S 100 E,
AMERICAN FORK, UTAH 84003

VICINITY MAP

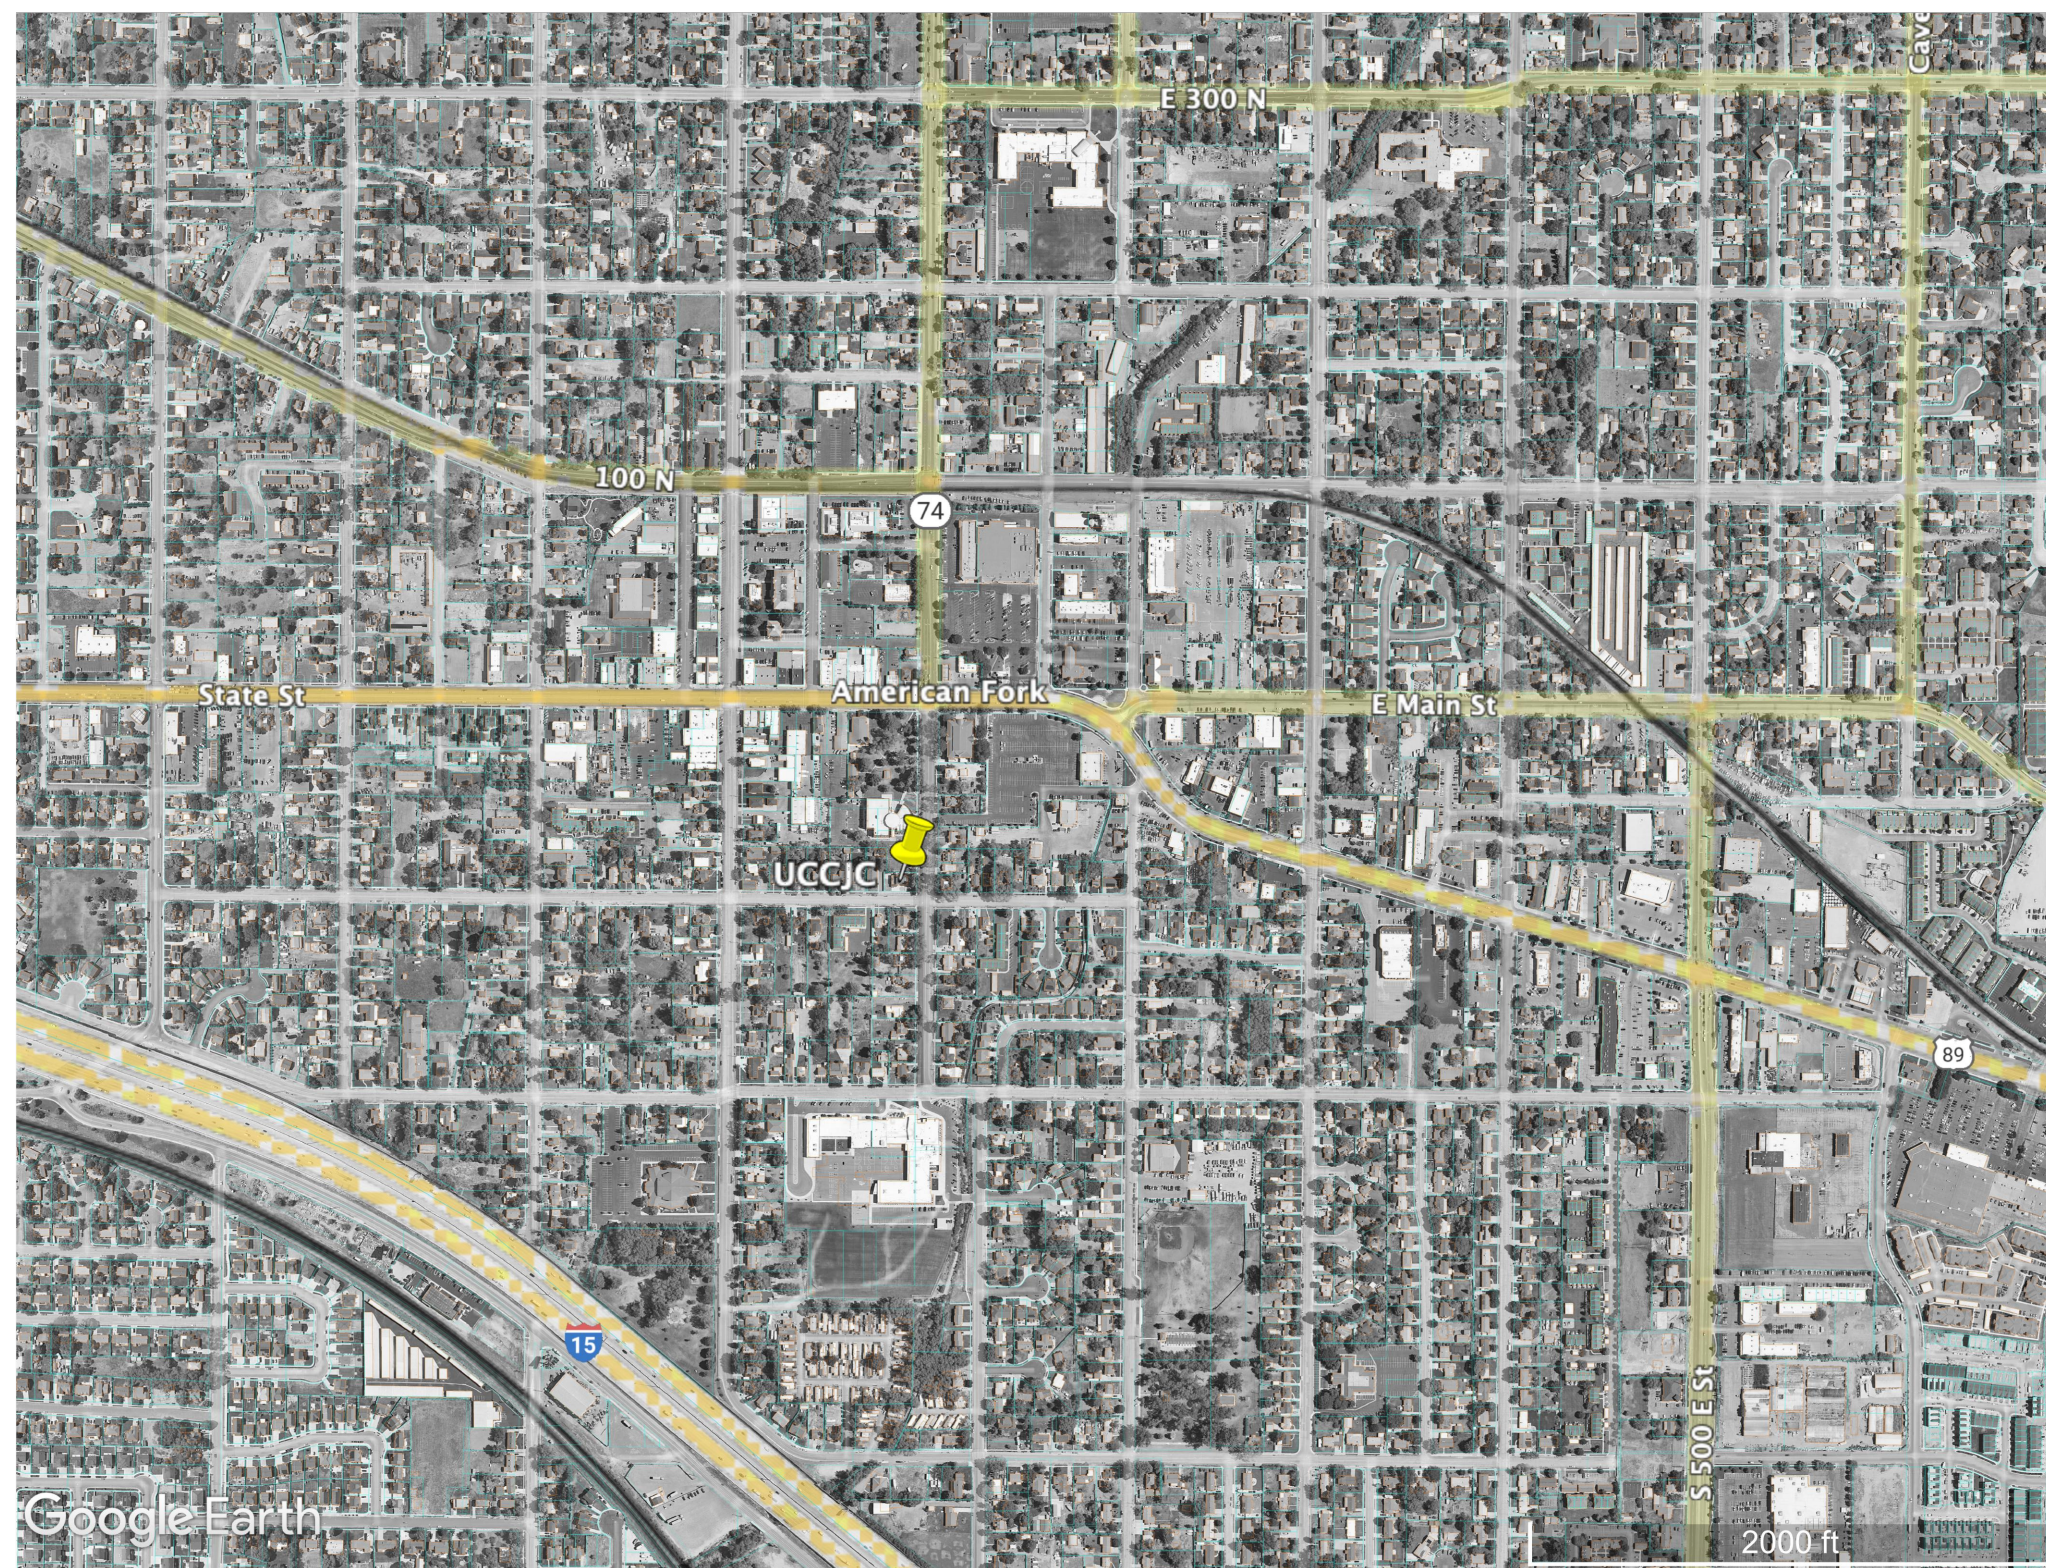

INDEX

- C-0 Cover Sheet
- C-1 Site Plan
- C-2 Grading Plan
- C-3 Utility Plan
- C-4 Details



American Fork City
Development Review
Committee

PLANNING AND ZONING APPROVED
TVANEKELEBURG
3/1/23

Engineering Division
Reviewed
Iburr 03/01/2023

CIVIL ENGINEER
LEGEND ENGINEERING
CAL JOHNSON
52 WEST 100 NORTH
HEBER CITY, UTAH 84032
(435) 654-4828

SURVEYOR
AZTEC ENGINEERING
AARON THOMAS
732 NORTH 780 WEST
AMERICAN FORK, UTAH 84003
PHONE

CONTRACTOR
THE CM PROS
DAVID THORNE
(801) 919-9858

LEGEND & ABBREVIATION TABLE

R.O.W./PROPERTY LINE	=====	EXISTING CURB AND GUTTER	=====
EASEMENT LINE	-----	PROPOSED CURB AND GUTTER	=====
CENTER LINE	-----	INVERT ELEVATION	IE
PROPOSED TRAIL	~~~~~	TOP BACK CURB	TBC
PROPOSED WATER LINE	—W—W—	TOP ASPHALT	TA
PROPOSED PRESSURIZED IRRIGATION	—PI—PI—	TOP OF GRATE	TOG
PROPOSED SEWER LINE	—SS—SS—	FINISHED GRADE	FG
PROPOSED STORM DRAIN LINE	—SD—SD—	TOP OF CONCRETE	TC
EXISTING SEWER LINE	---SS---SS---	HIGH WATER ELEVATION	HWE
EXISTING WATER LINE	---W---W---	CATCH BASIN	
EXISTING STORM DRAIN LINE	---SD---SD---	PROPOSED STREET LIGHT	
EXISTING CONTOUR	~~~~~	STORM DRAIN MANHOLE	
FINISHED CONTOUR	~~~~~	SANITARY SEWER MANHOLE	
		PROPOSED WATER VALVE	

Company : AF Public Works

- Culinary Water/P.I.
- Sewer/Storm Drain
- City Inspector
- SWPPP Inspector
- AF Fiber
- AF Fire Marshall
- AF Irrigation Company
- Blue Stake UT 811
- Comcast
- Century Link
- Dominion Energy
- T.S.S.D.
- Mitchell Hollow Irrigation Co.
- Rocky Mountain Power

Contact

- Jay Brems
- Ashton Hardy
- Dee Howard
- Harlan Nielson
- Will Davis
- Mat Sacco
- Ernie John
- Elysia Valdez
- Bill Westfall
- Trent Johnson
- David Barlow
- Dale Jones
- Teria Walker

Number

- (801)763-3060
- (801)763-3060
- (801)763-3060
- (801)763-3060
- (801)897-9826
- (801)763-3045
- (801)471-6576
- (800)662-4111
- (801)401-3017
- (435)623-4252
- (801)853-6548
- (801)756-5231
- (801)768-8150
- (801)756-1310

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UTAH COUNTY CHILDREN'S JUSTICE CENTER

COVER SHEET
96 S 100 E, AMERICAN FORK CITY, UTAH 84003




SHEET:

C-0

PLANNING COMMISSION

DATE: 2/16/2023

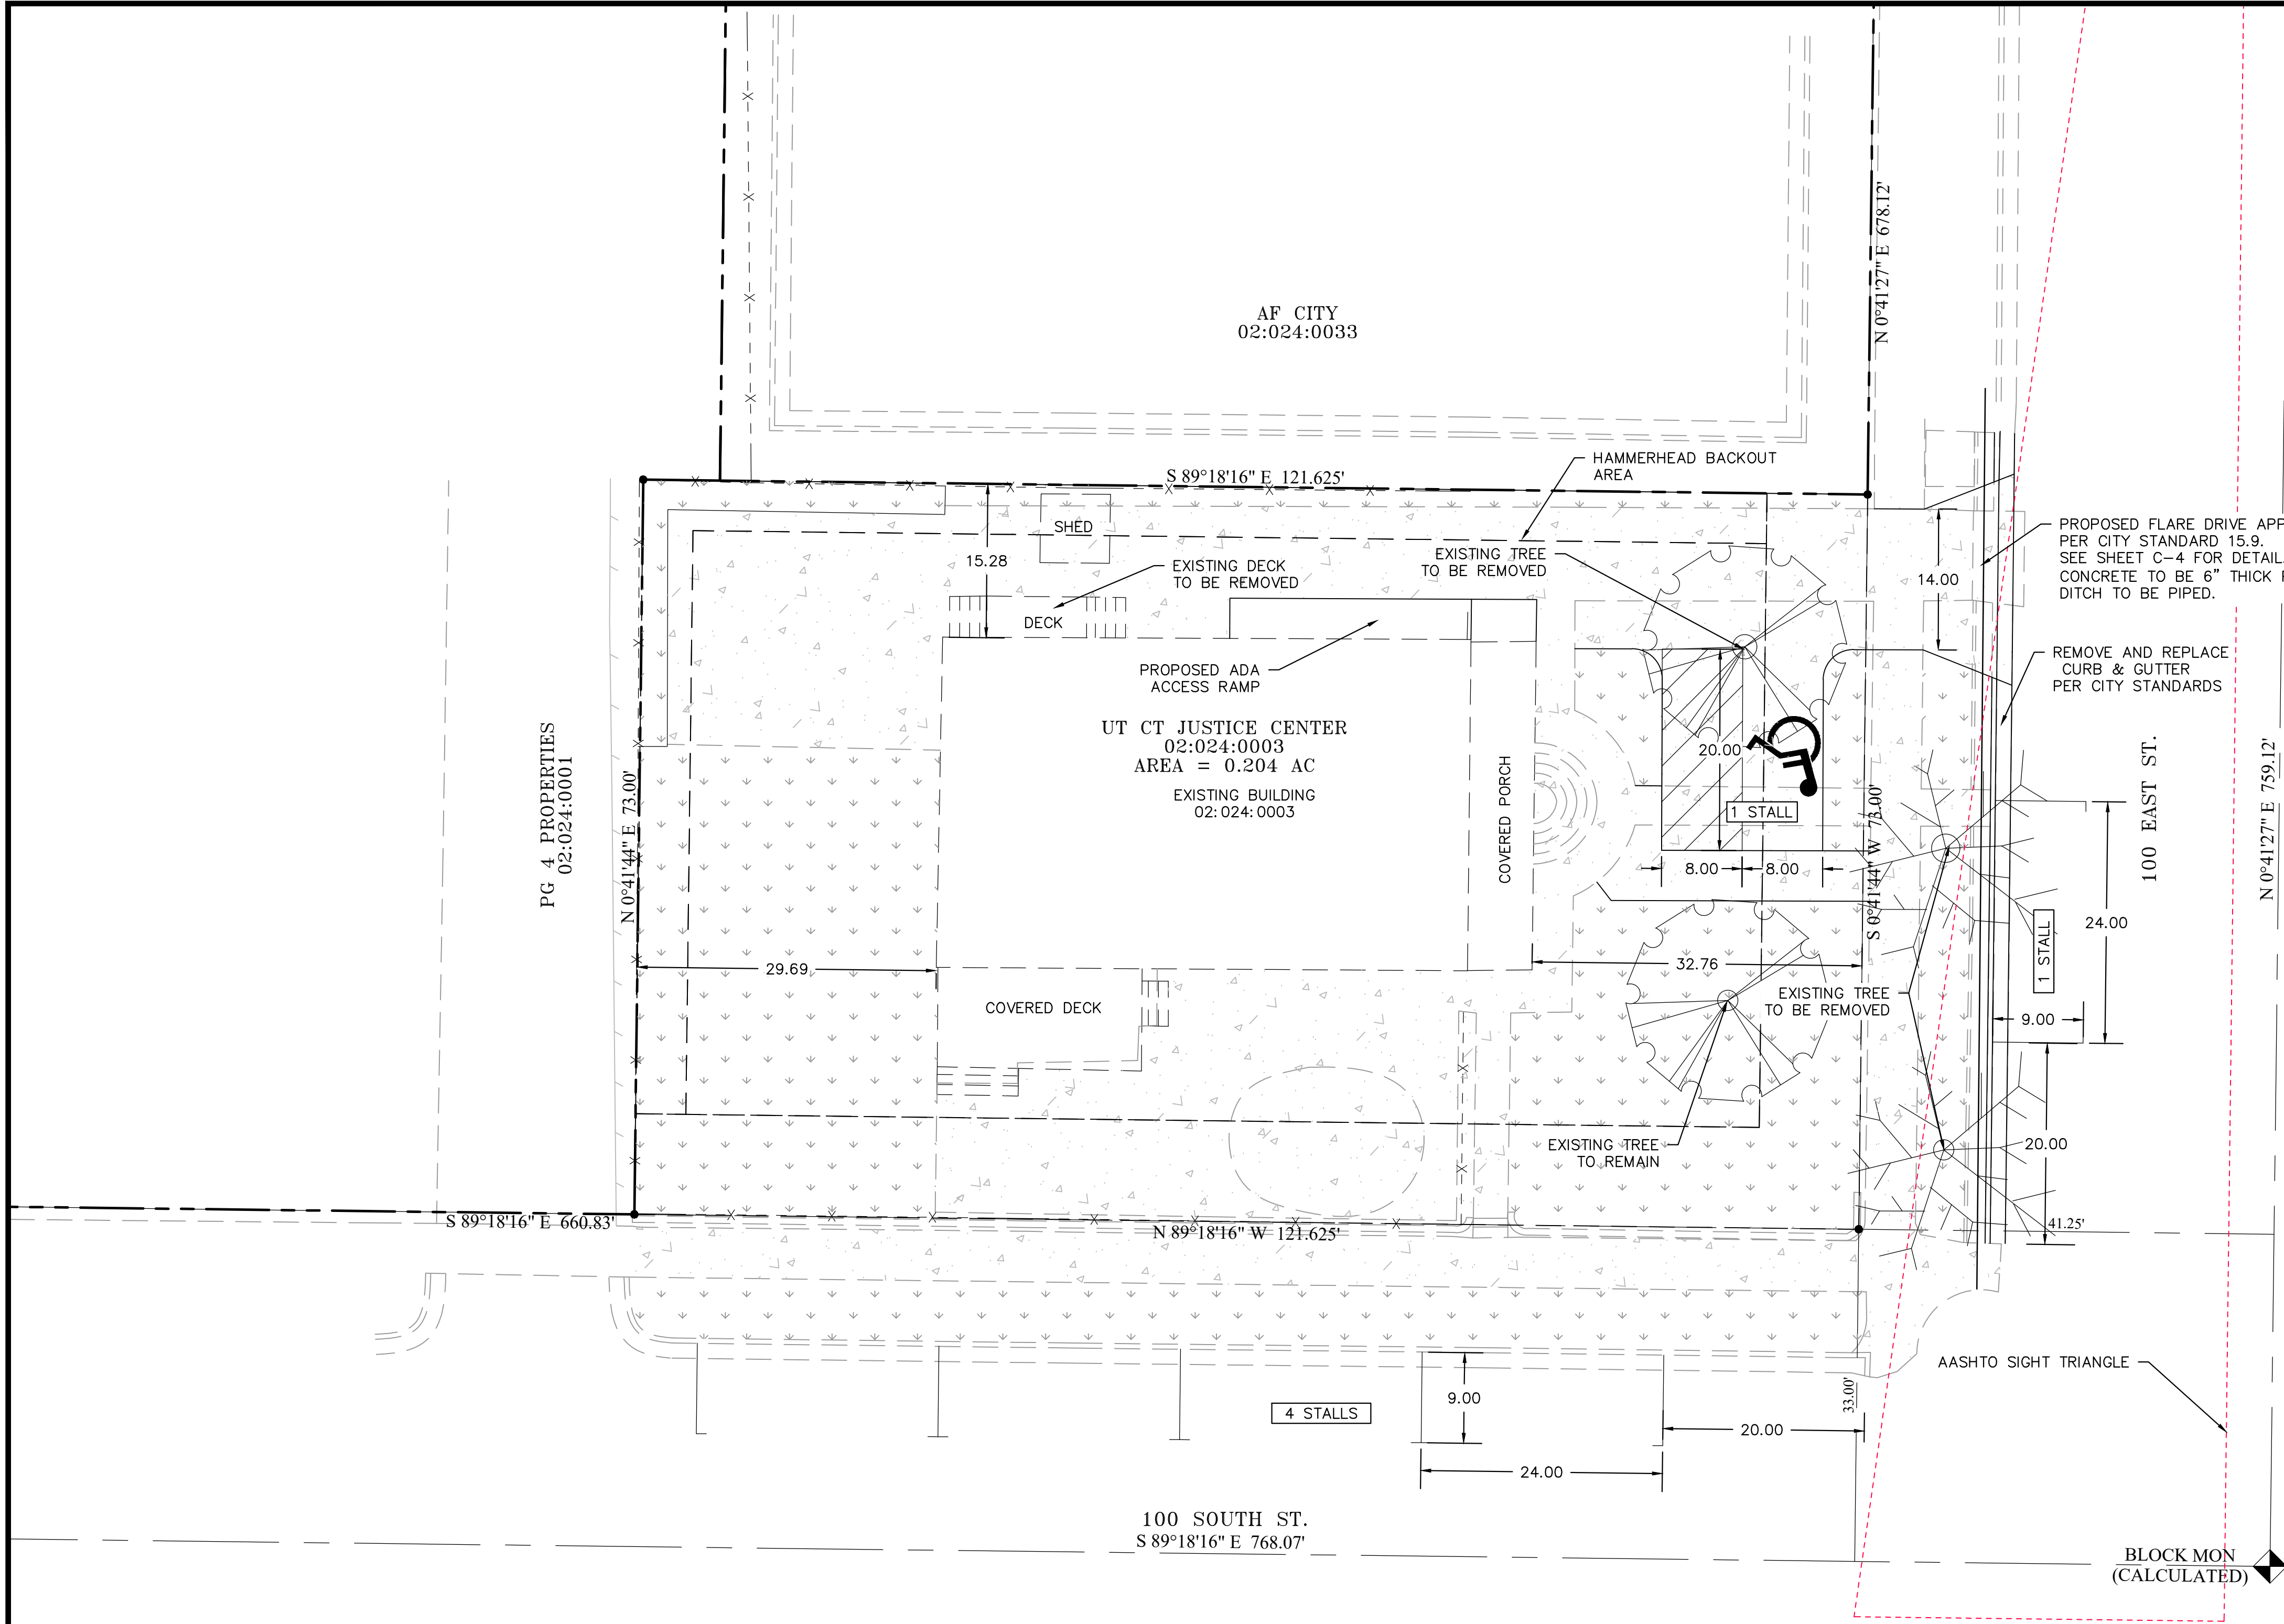


LOT LINES (PROPERTY)	---
EXISTING CURB AND GUTTER	==
PROPOSED CURB AND GUTTER	==
SETBACK LINE	---
EXISTING FENCE	-X-
LANDSCAPE AREA	[Pattern]
CONCRETE AREA	[Pattern]
GRADE BREAK	GB
INVERT ELEVATION	IE
TOP OF GRATE	TOG
TOP OF ASPHALT	TA
TOP BACK OF CURB	TBC
PROPOSED	PROP
EXISTING	EX
FINISHED GRADE	FG
FINISHED FLOOR ELEVATION	FFE
BACK OF SIDEWALK	BOW

SITE DATA		
LOT AREA:	8,886	SF (0.20 ACRES)
BUILDING AREA:	2,185	SF± 24.6%
PAVEMENT AREA:	3,769	SF± 42.4%
LANDSCAPE AREA:	2,932	SF± 33.0%

BUILDING DATA
ZONE: CC-1 (CENTRAL COMMERCIAL ZONE)

PARKING TABULATION
PROVIDED: 1 STALL ON SITE (1 ADA)
5 ON STREET STALLS


- GENERAL NOTES:
- CONTRACTOR SHALL CALL 811 PRIOR TO CONSTRUCTION.
 - CONTRACTOR SHALL VERIFY LOCATION AND ELEVATION OF ALL EXISTING UTILITY LINES AND STRUCTURES PRIOR TO CONSTRUCTION.
 - ALL PROPOSED WATER LINES SHALL HAVE A MINIMUM OF 5' OF COVER.
 - ALL SEWER, WATER AND STORM DRAIN PIPES SHALL BE BACKFILLED WITH SELECT GRANULAR FILL AS PER CITY STANDARDS.
 - ANY OFF SITE DAMAGE TO EXISTING ASPHALT, CURB & GUTTER, LANDSCAPING AND ALL UTILITIES SHALL BE REPLACED IN KIND.
 - SEE UTILITY PLAN FOR CONSTRUCTION OF SEWER AND WATER LINES.
 - ALL WORK SHALL BE ACCORDING TO CITY STANDARDS.

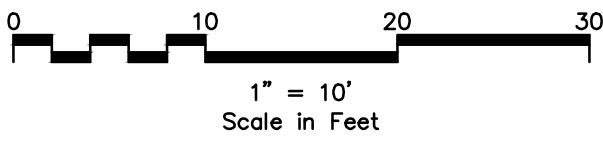


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HEBER CITY, UT 84032
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


UTAH COUNTY CHILDREN'S JUSTICE CENTER
SITE PLAN
96 S 100 E, AMERICAN FORK CITY, UTAH 84003

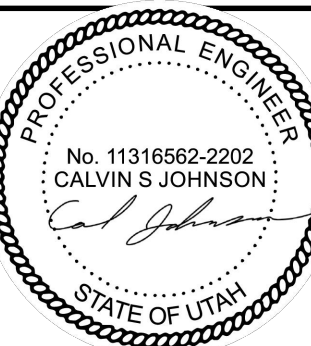

SHEET:
C-1
DATE: 2/22/2023



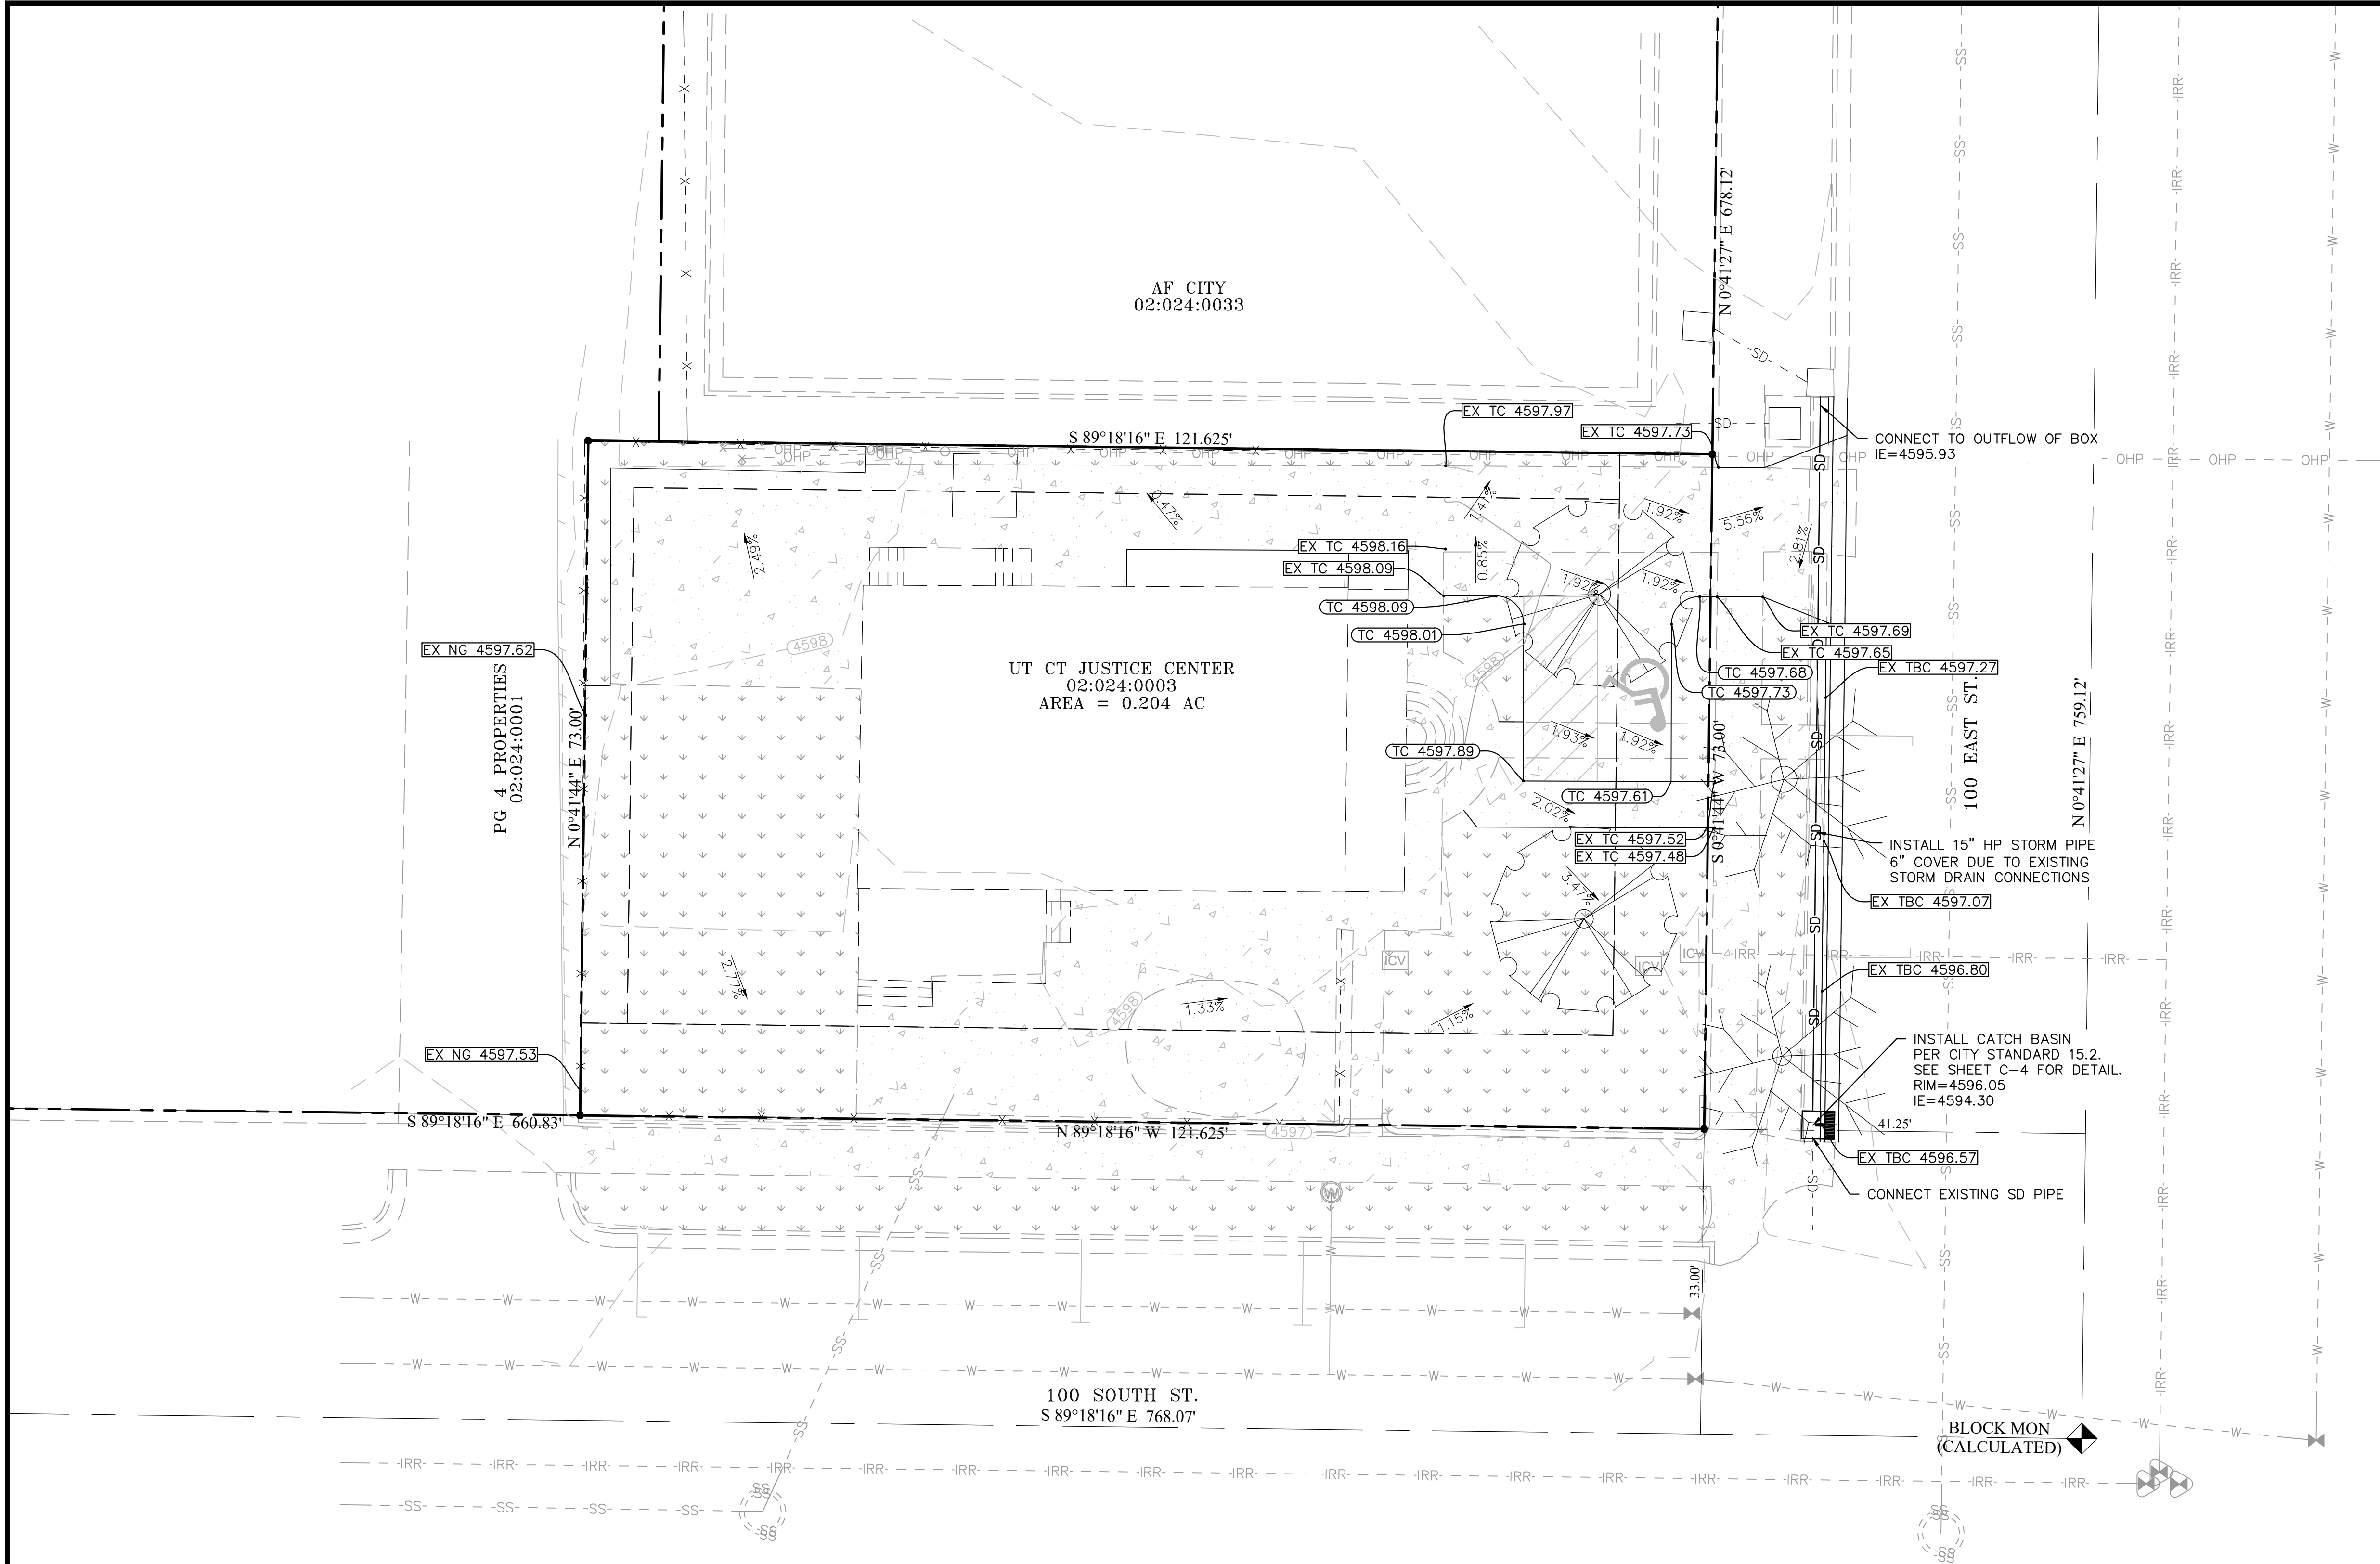




LOT LINES (PROPERTY) --- --
EXISTING CURB AND GUTTER ====
PROPOSED CURB AND GUTTER ====

PROPOSED STORM DRAIN LINE ---SD---
EXISTING STORM DRAIN LINE ---SD---
PROPOSED SEWER LINE ---SS---
EXISTING SEWER LINE ---SS---
PROPOSED WATER LINE ---W---
EXISTING WATER LINE ---W---
EXISTING FENCE ---X---
GRADE BREAK ---GRADE BREAK---
FINISH GRADE CONTOUR LINES ---4960---
EXISTING GRADE CONTOUR LINES ---4960---

FINISH GRADE SLOPE ---SLOPE---
GRADE BREAK GB
INVERT ELEVATION IE
TOP OF GRATE TOG
TOP OF ASPHALT TA
TOP OF CONCRETE TC
PROPOSED PROP
EXISTING EX
FINISHED GRADE FG
FINISHED FLOOR ELEVATION FFE
BACK OF SIDEWALK BOW

LANDSCAPE AREA [Pattern]
CONCRETE AREA [Pattern]

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1" = 10'
Scale in Feet

ENGINEER: CJ CHECKED BY: LR


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UTAH COUNTY CHILDREN'S JUSTICE CENTER
GRADING AND DRAINAGE PLAN
96 S 100 E, AMERICAN FORK CITY, UTAH 84003

PROFESSIONAL ENGINEER
No. 11316562-2202
CALVIN S. JOHNSON
STATE OF UTAH


SHEET: C-2

DATE: 2/16/2023

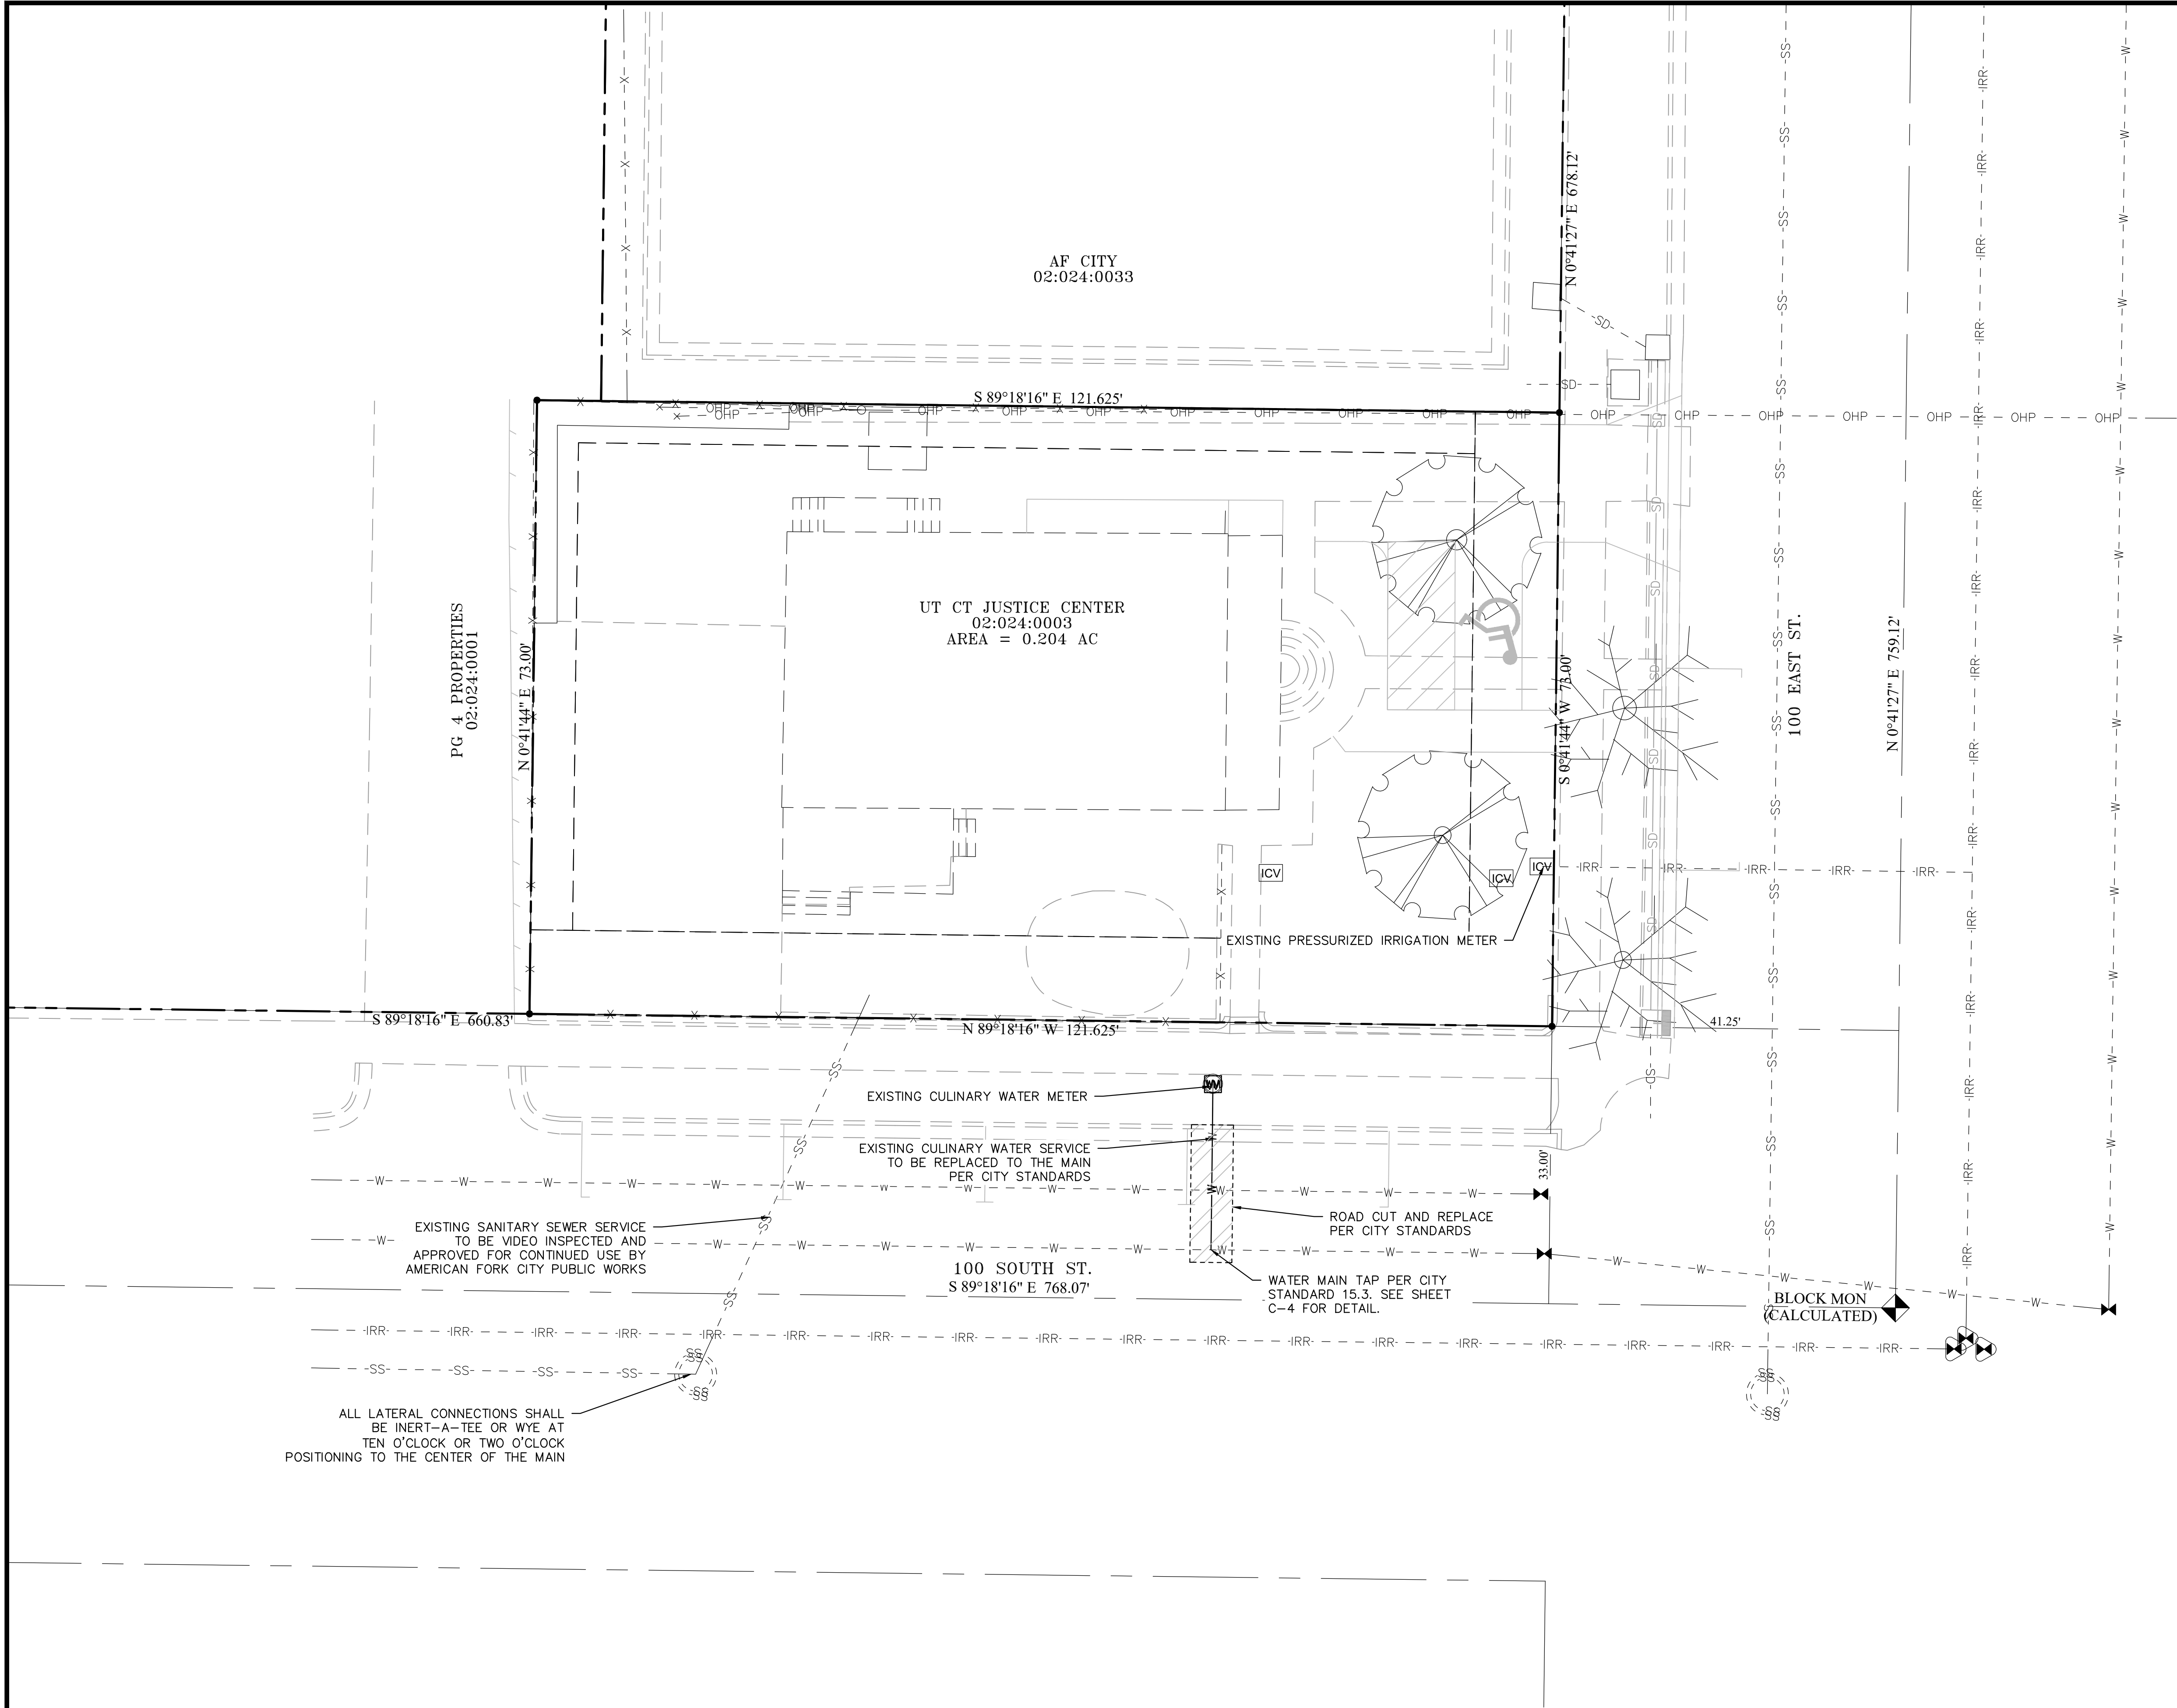

ALL LATERAL CONNECTIONS SHALL
BE INERT-A-TEE OR WYE AT
TEN O'CLOCK OR TWO O'CLOCK
POSITIONING TO THE CENTER OF THE MAIN

- GENERAL NOTES:
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PROPERTY/ROW LINE	---
EXISTING CURB AND GUTTER	==
PROPOSED CURB AND GUTTER	==
PROPOSED STORM DRAIN LINE	-SD-
EXISTING STORM DRAIN LINE	-SS-
PROPOSED SEWER LINE	-SS-
EXISTING SEWER LINE	-SS-
PROPOSED WATER LINE	-W-
EXISTING WATER LINE	-W-
EXISTING GAS LINE	-G-
INVERT ELEVATION	IE
PROPOSED	PROP
FINISHED FLOOR ELEVATION	FFE
EXISTING FIRE HYDRANT	⊗
EXISTING WATER VALVE	⊗
EXISTING WATER METER	⊗
EXISTING SEWER MANHOLE	⊗
PROPOSED FIRE HYDRANT	⊗
PROPOSED WATER VALVE	⊗
PROPOSED WATER METER	⊗
PROPOSED SEWER CLEANOUT	⊗
PROPOSED SEWER MANHOLE	⊗
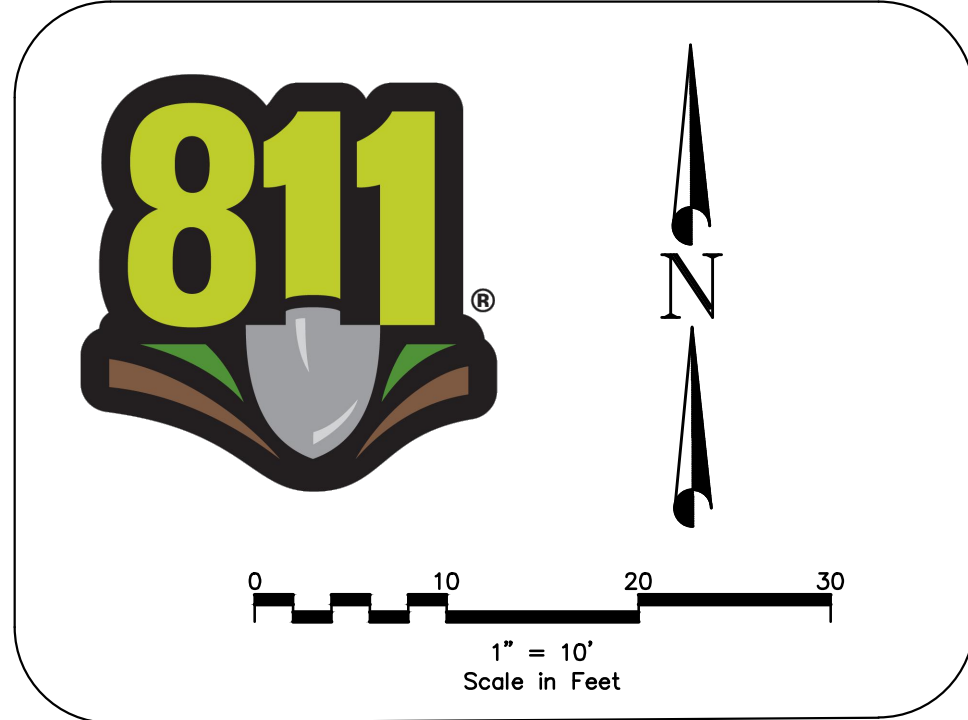
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UTILITY PLAN
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STATE OF UTAH

ENGINEER: CJ
CHECKED BY: LR

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SHEET: C-3

